
CAMP RESIDENCE

Barbara Camp Lot #5 Dickson Drive Malvern, PA 19355

Charlestown Township, Chester County

NEW RESIDENCE

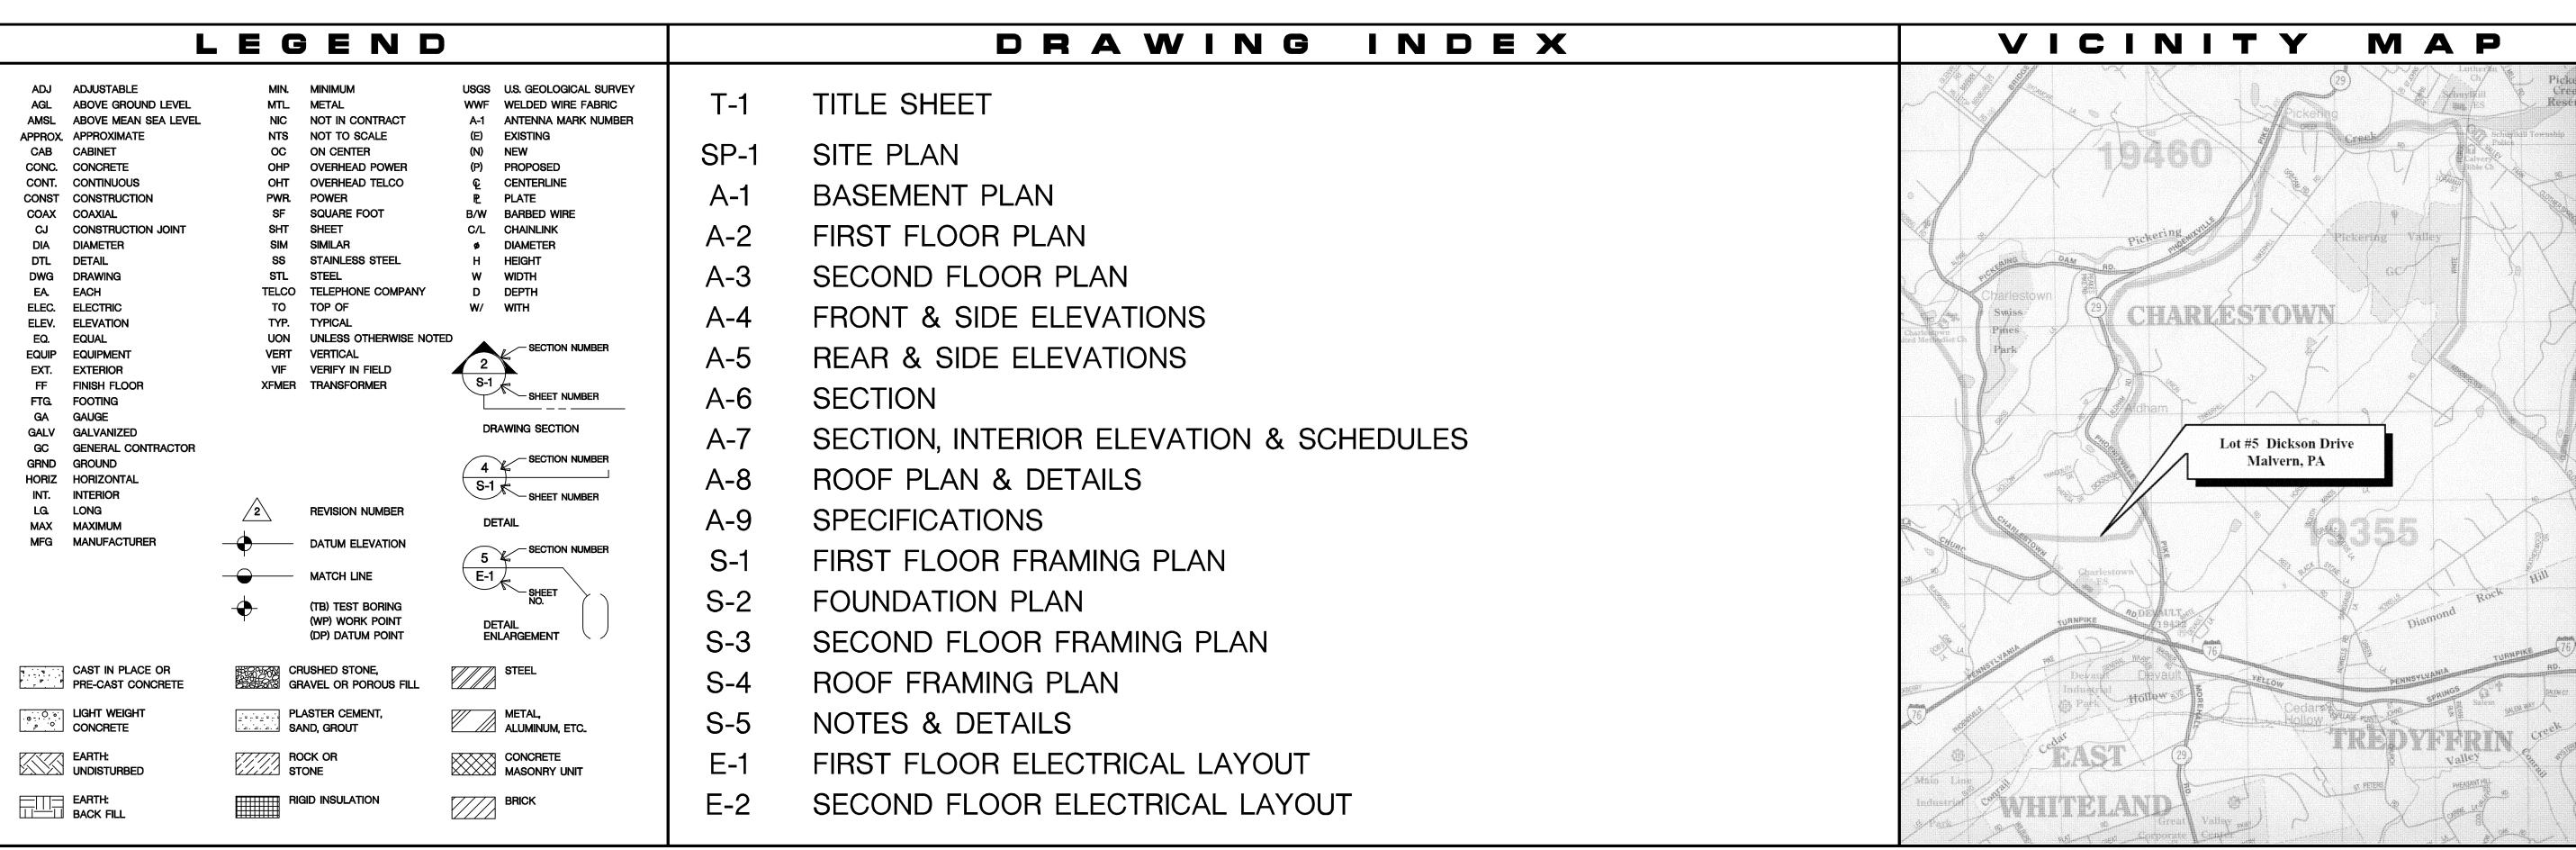

GENERAL NOTES

- ALL WORK SHALL BE DONE IN ACCORDANCE WITH THE LATEST EDITION OF THE IBC CODE ADOPTED BY CHARLESTOWN TOWNSHIP, CHESTER COUNTY IN THE COMMONWEALTH OF PENNSYLVANIA.
- 2) GENERAL CONTRACTOR SHALL VERIFY ALL EXISTING DIMENSIONS, STRUCTURE AND MATERIALS, AND SHALL BRING ANY DISCREPANCIES TO THE IMMEDIATE ATTENTION OF THE ARCHITECT.
- 3) ALL FOOTING EXCAVATION SHALL BE CARRIED A MINIMUM OF 18" INTO SOLID UNDISTURBED SOIL HAVING A MINIMUM BEARING CAPACITY OF 3,000 PSF. BOTTOMS OF ALL FOOTINGS SHALL BE A MINIMUM OF 3'-0" BELOW FINISHED GRADE.
- 4) ALL CONCRETE SHALL HAVE A MINIMUM COMPRESSIVE STRENGTH OF 3,500 PSI AFTER 28 DAYS.
- 5) 4" DIAMETER PVC PERFORATED FOOTING DRAINS SHALL BE INSTALLED IN GRAVEL BEDS WITH FABRIC WRAP PROTECTION AT OWNERS / CONTRACTOR'S
- 6) STRUCTURAL BEAMS AND COLUMNS SHALL BE WPA SELECT STRUCTURAL HEM/FIR NO. I HAVING A FB OF 975 PSI. FLOOR AND CEILING JOISTS AND RAFTERS SHALL BE WPA #2 GRADE HEM/FIR HAVING A FB OF 850 PSI. WALL STUDS SHALL BE WPA #2 GRADE HEM/FIR HAVING A FB OF 675 PSI.

- 6.1) ALL EXTERIOR DECKING, POSTS, AND JOISTS SHALL BE PRESSURE-TREATED U.N.O.
- 6.2) WOOD SILLS ON CONCRETE OR CMU SHALL BE PRESSURE-TREATED AND PROVIDED WITH TERMITE SHIELDS AT ALL FOUNDATION WALLS.
- 6.3) ALL EXTERIOR NAILS, BOLTS, ANCHORS, AND HANGERS SHALL BE STAINLESS STEEL OR TRIPLE HOT DIPPED GALVANIZED.
- 6.4) DOUBLE FLOOR JOISTS SHALL BE INSTALLED UNDER ALL PARTITIONS WHICH ARE PARALLEL TO JOISTS.
- 6.5) ALL JOISTS SHALL HAVE SOLID BRIDGED AT 6'-0" O.C. (MAX.). JOISTS SPANNING LESS THAT 12'-0" SHALL BE BRIDGED AT MIDSPAN
- 6.6) SHADED PARTITIONS INDICATE 2X6 STUDS.
- 6.7) DARKENED POSTS INDICATE 2 STUD MINIMUM, UNLESS NOTED OTHERWISE.
- 7) ALL CORNERS OF THE STRUCTURE SHALL BE SHEATHED WITH 1/2" APA RATED SHEATHING, EXPOSURE I NAILED WITH 6D COMMON NAILS 6" O.C. (MAX.) AT PANEL EDGES AND 12" O.C. (MAX.) AT INTERMEDIATE SUPPORTS. BALANCE OF SHEATHING SHALL BE AT OWNER / BUILDER'S OPTION.

- 8) BUILDING SHALL BE SHEATHED WITH (MIN.) 30# ASPHALT-IMPREGNATED FELT OR TYVEK HOUSE WRAP.
- 9) WINDOW SIZES ARE BASED UPON PELLA WINDOWS. ALL GLAZING OVER 9 SQUARE FEET AND/OR WITHIN 18" OF FLOOR AND IN HAZARDOUS LOCATIONS SHALL BE TEMPERED.
- 10) ALL STUD FRAMED WALLS GREATER THAN 8'-6" VERTICALLY SHALL BE LATERIALLY BRACED AT THE MIDPOINT WITH SOLID BLOCKING.
- 11) INTERIOR PARTITIONS SHALL RECEIVE 1/2" (MIN.) GYPSUM DRYWALL.
- NO BACKFILLING OR ROUGH GRADING SHALL BE DONE UNTIL THE CONCRETE 12) FOUNDATION AND SLAB HAS CURED FOR A MINIMUM OF 14 DAYS.
- 13) ALL DIMENSIONS ARE TO ROUGH STUD FACE, CONCRETE OR C.M.U. FACE. AND EXTERIOR SHEATHING FACE.
- 14) MASONRY AND STONE VENEERS SHALL BE ANCHORED TO SHEATHING WITH GALVANIZED CORRUGATED METAL TIES AT 32" O.C. HORIZONTALLY AND 16" O.C. VERTICALLY. FLASHING SHALL EXTEND BELOW MASONRY OR STONE AT ALL SILLS; WEEP HOLES SHALL BE PROVIDED AT 4'-0" O.C. AT BASE OF CAVITY.

- 15) METAL HEAD FLASHING SHALL BE INSTALLED IN ALL WINDOWS THAT ARE NOT LOCATED IMMEDIATELY BELOW AN 8" (MINIMUM) EAVE PROJECTION. MINIMUM 6" WIDE 30# BUILDING PAPER FLASHING SHALL BE INSTALLED AROUND ALL PRIMED WOOD WINDOWS.
- 16) ALLOW A MINIMUM OF 8" BETWEEN THE TOP OF FOUNDATION AND GRADE AND A MINIMUM OF 6" BETWEEN FINISH GRADE AND SHEATHING OR SIDING.
- 17) ALL SMOKE DETECTORS SHALL BE INTERCONNECTED. ALL DETECTORS SHALL HAVE A PRIMARY 120 VOLT SUPPLY AND A SECONDARY SYSTEM CONSISTING OF A BATTERY BACK-UP.
- CONSULT MANUFACTURER SPECIFICATIONS OF ENGINEERED LUMBER. PAY PARTICULAR ATTENTION TO ASSEMBLY OF MULTIPLE MEMBER BEAMS, NAILING PROCEDURES & CUT OUTS FOR UTILITIES.
- 19) GENERAL CONTRACTOR SHALL BE RESPONSIBLE FOR INSTALLATION AND ACCOMMODATION OF HVAC, PLUMBING, AND ELECTRICAL SYSTEMS. NO STRUCTURAL OR ARCHITECTURAL CHANGES SHALL BE MADE WITHOUT PRIOR APPROVAL BY THE ARCHITECT.



523 Kimberton Road, Suite 11B Phoenixville, PA 19460 tel. (610) 917-8831 email mail@betzwood.com http://www.betzwood.com

Robin I. Kohn AIA Commonwealth of Pennsylvania License No. RA-11327-X

> Contact Person: Edward M. Happ (610) 917-8831

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Camp Residence

LOT #5 DICKSON DRIVE MALVERN, PA 19355

CHARLESTOWN TWP. CHESTER COUNTY


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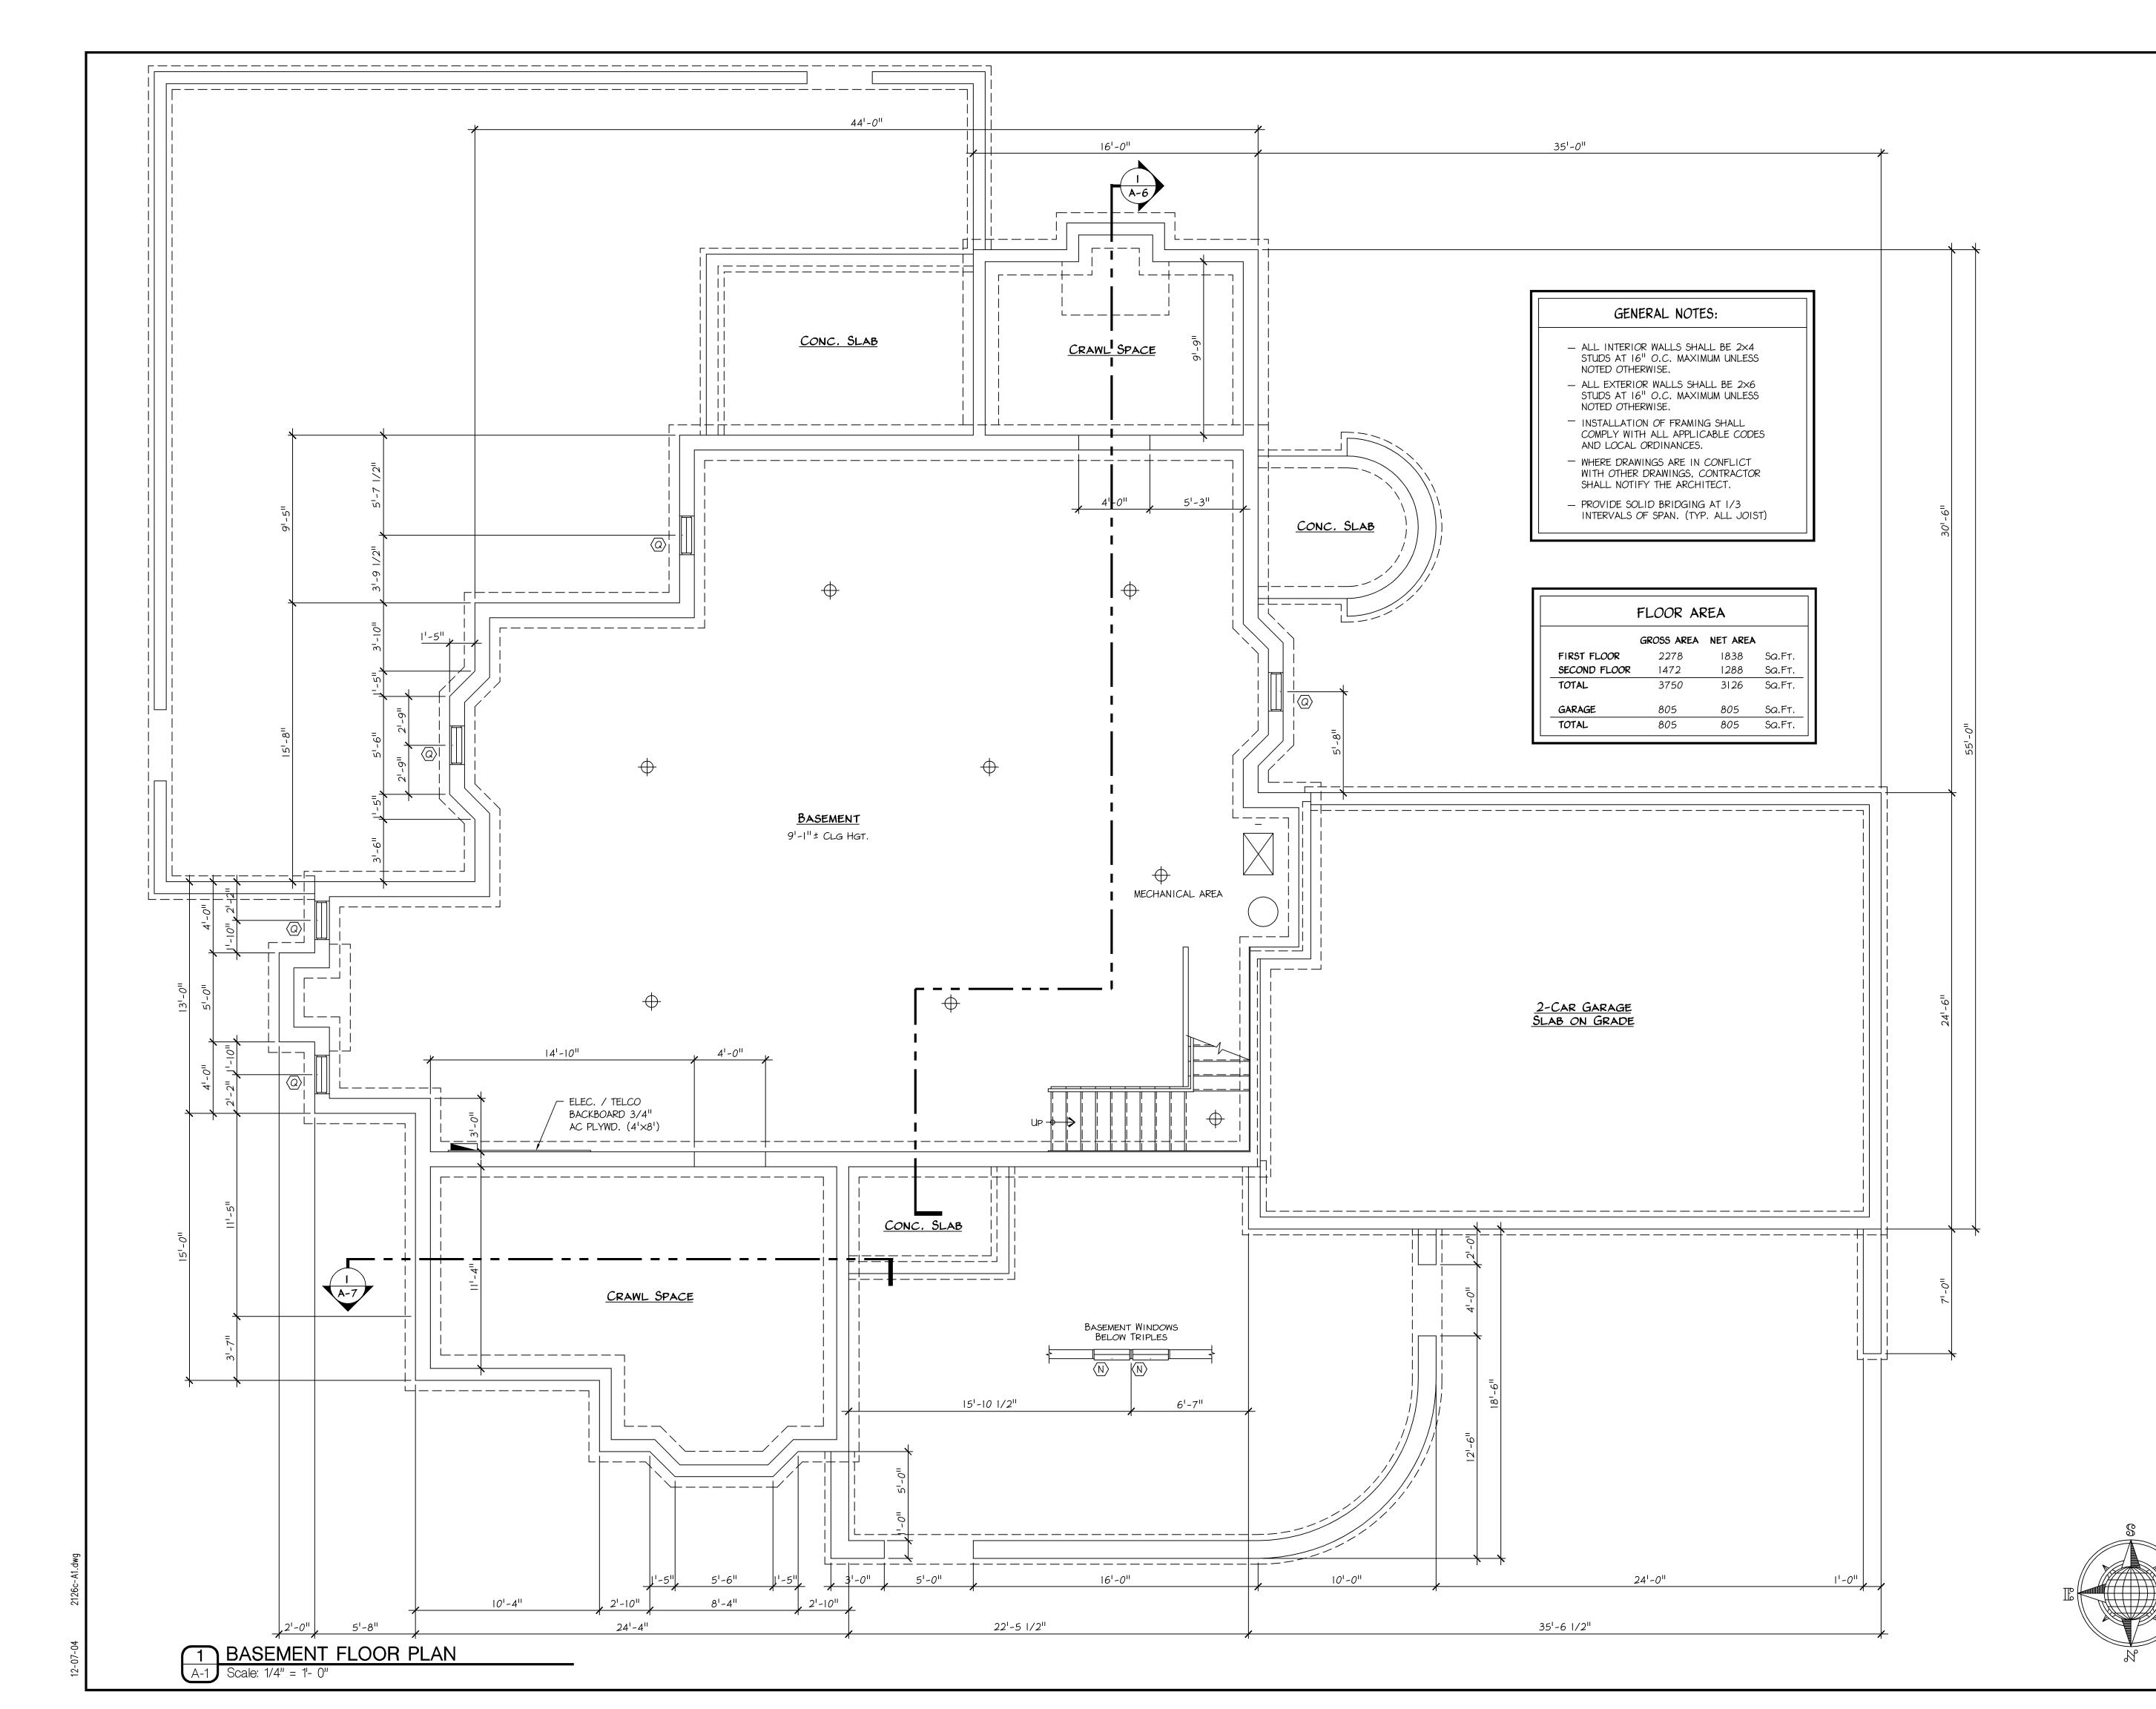
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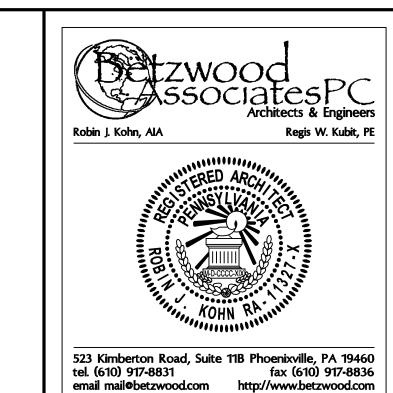
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Robin J. Kohn, AIA Commonwealth of Pennsylvania

License No. RA-11327-X

Contact Person: Edward M. Happ (610) 917-8831

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Camp Residence

LOT #5 DICKSON DRIVE MALVERN, PA 19355

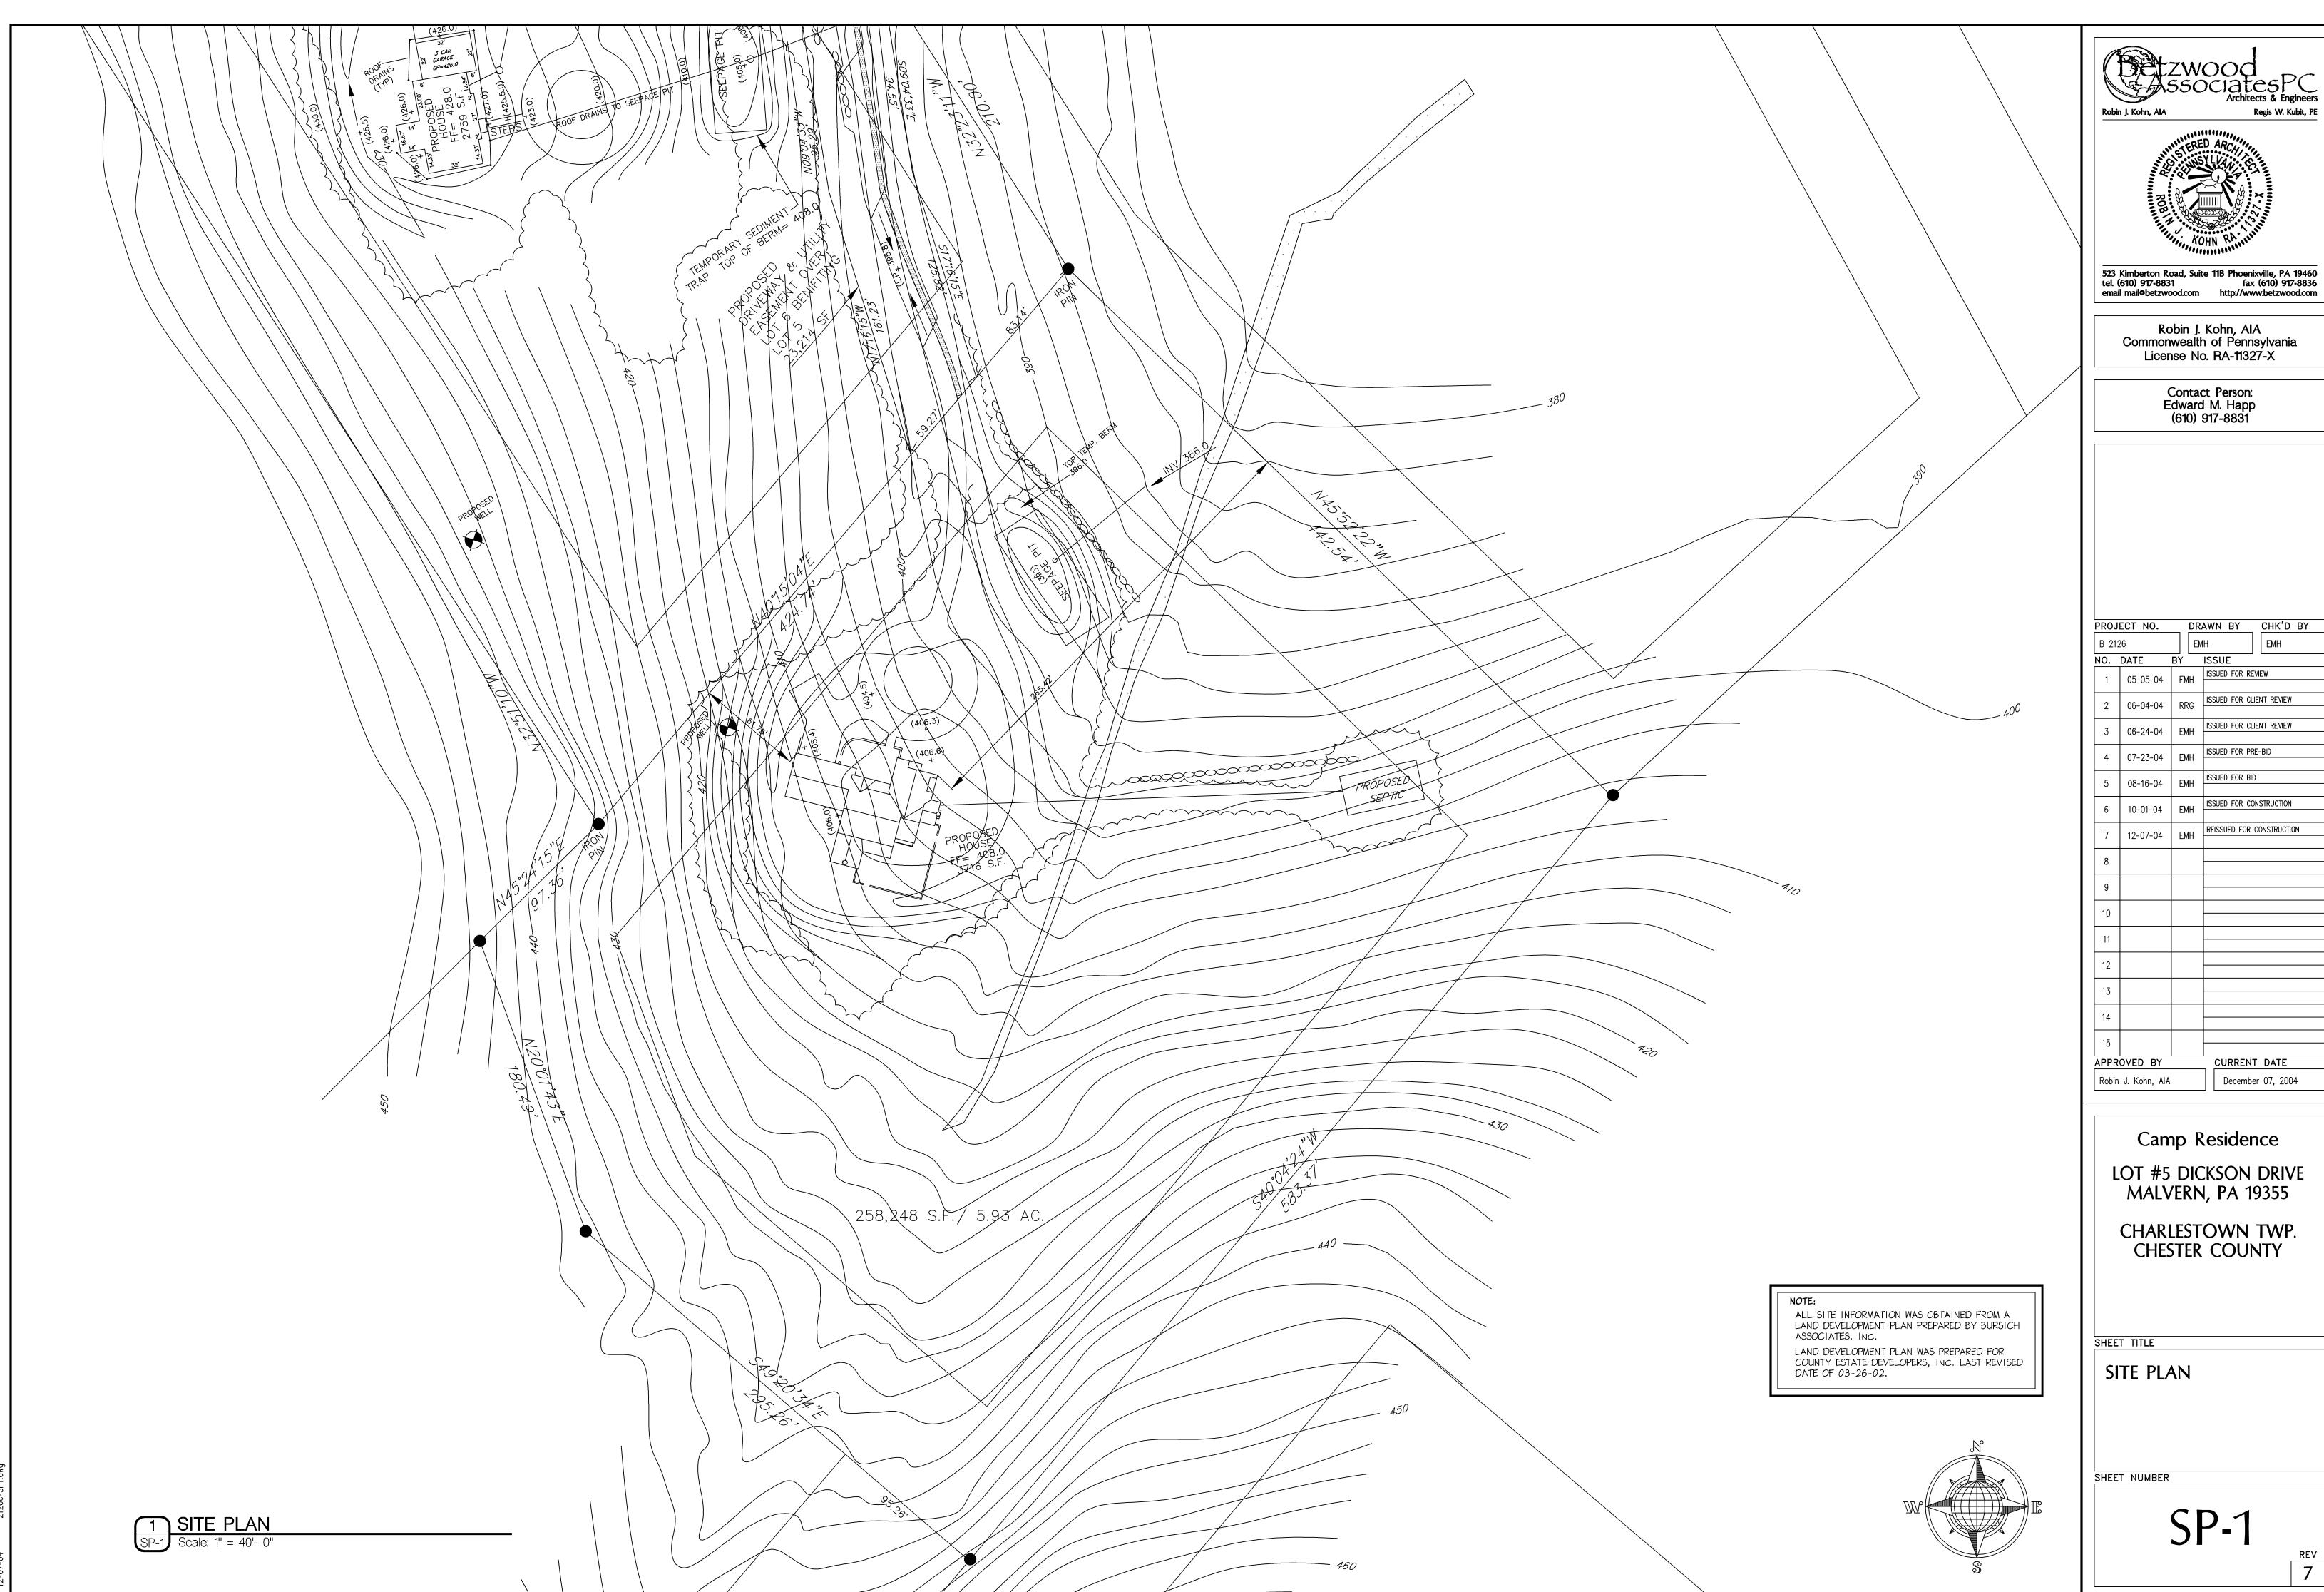CHARLESTOWN TWP.
CHESTER COUNTY


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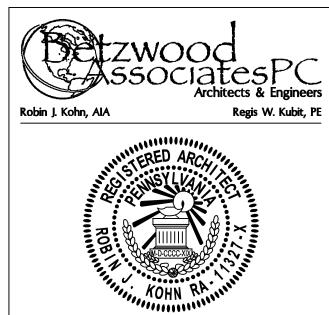
BASEMENT FLOOR PLAN

SHEET NUMBER

A-1

REV



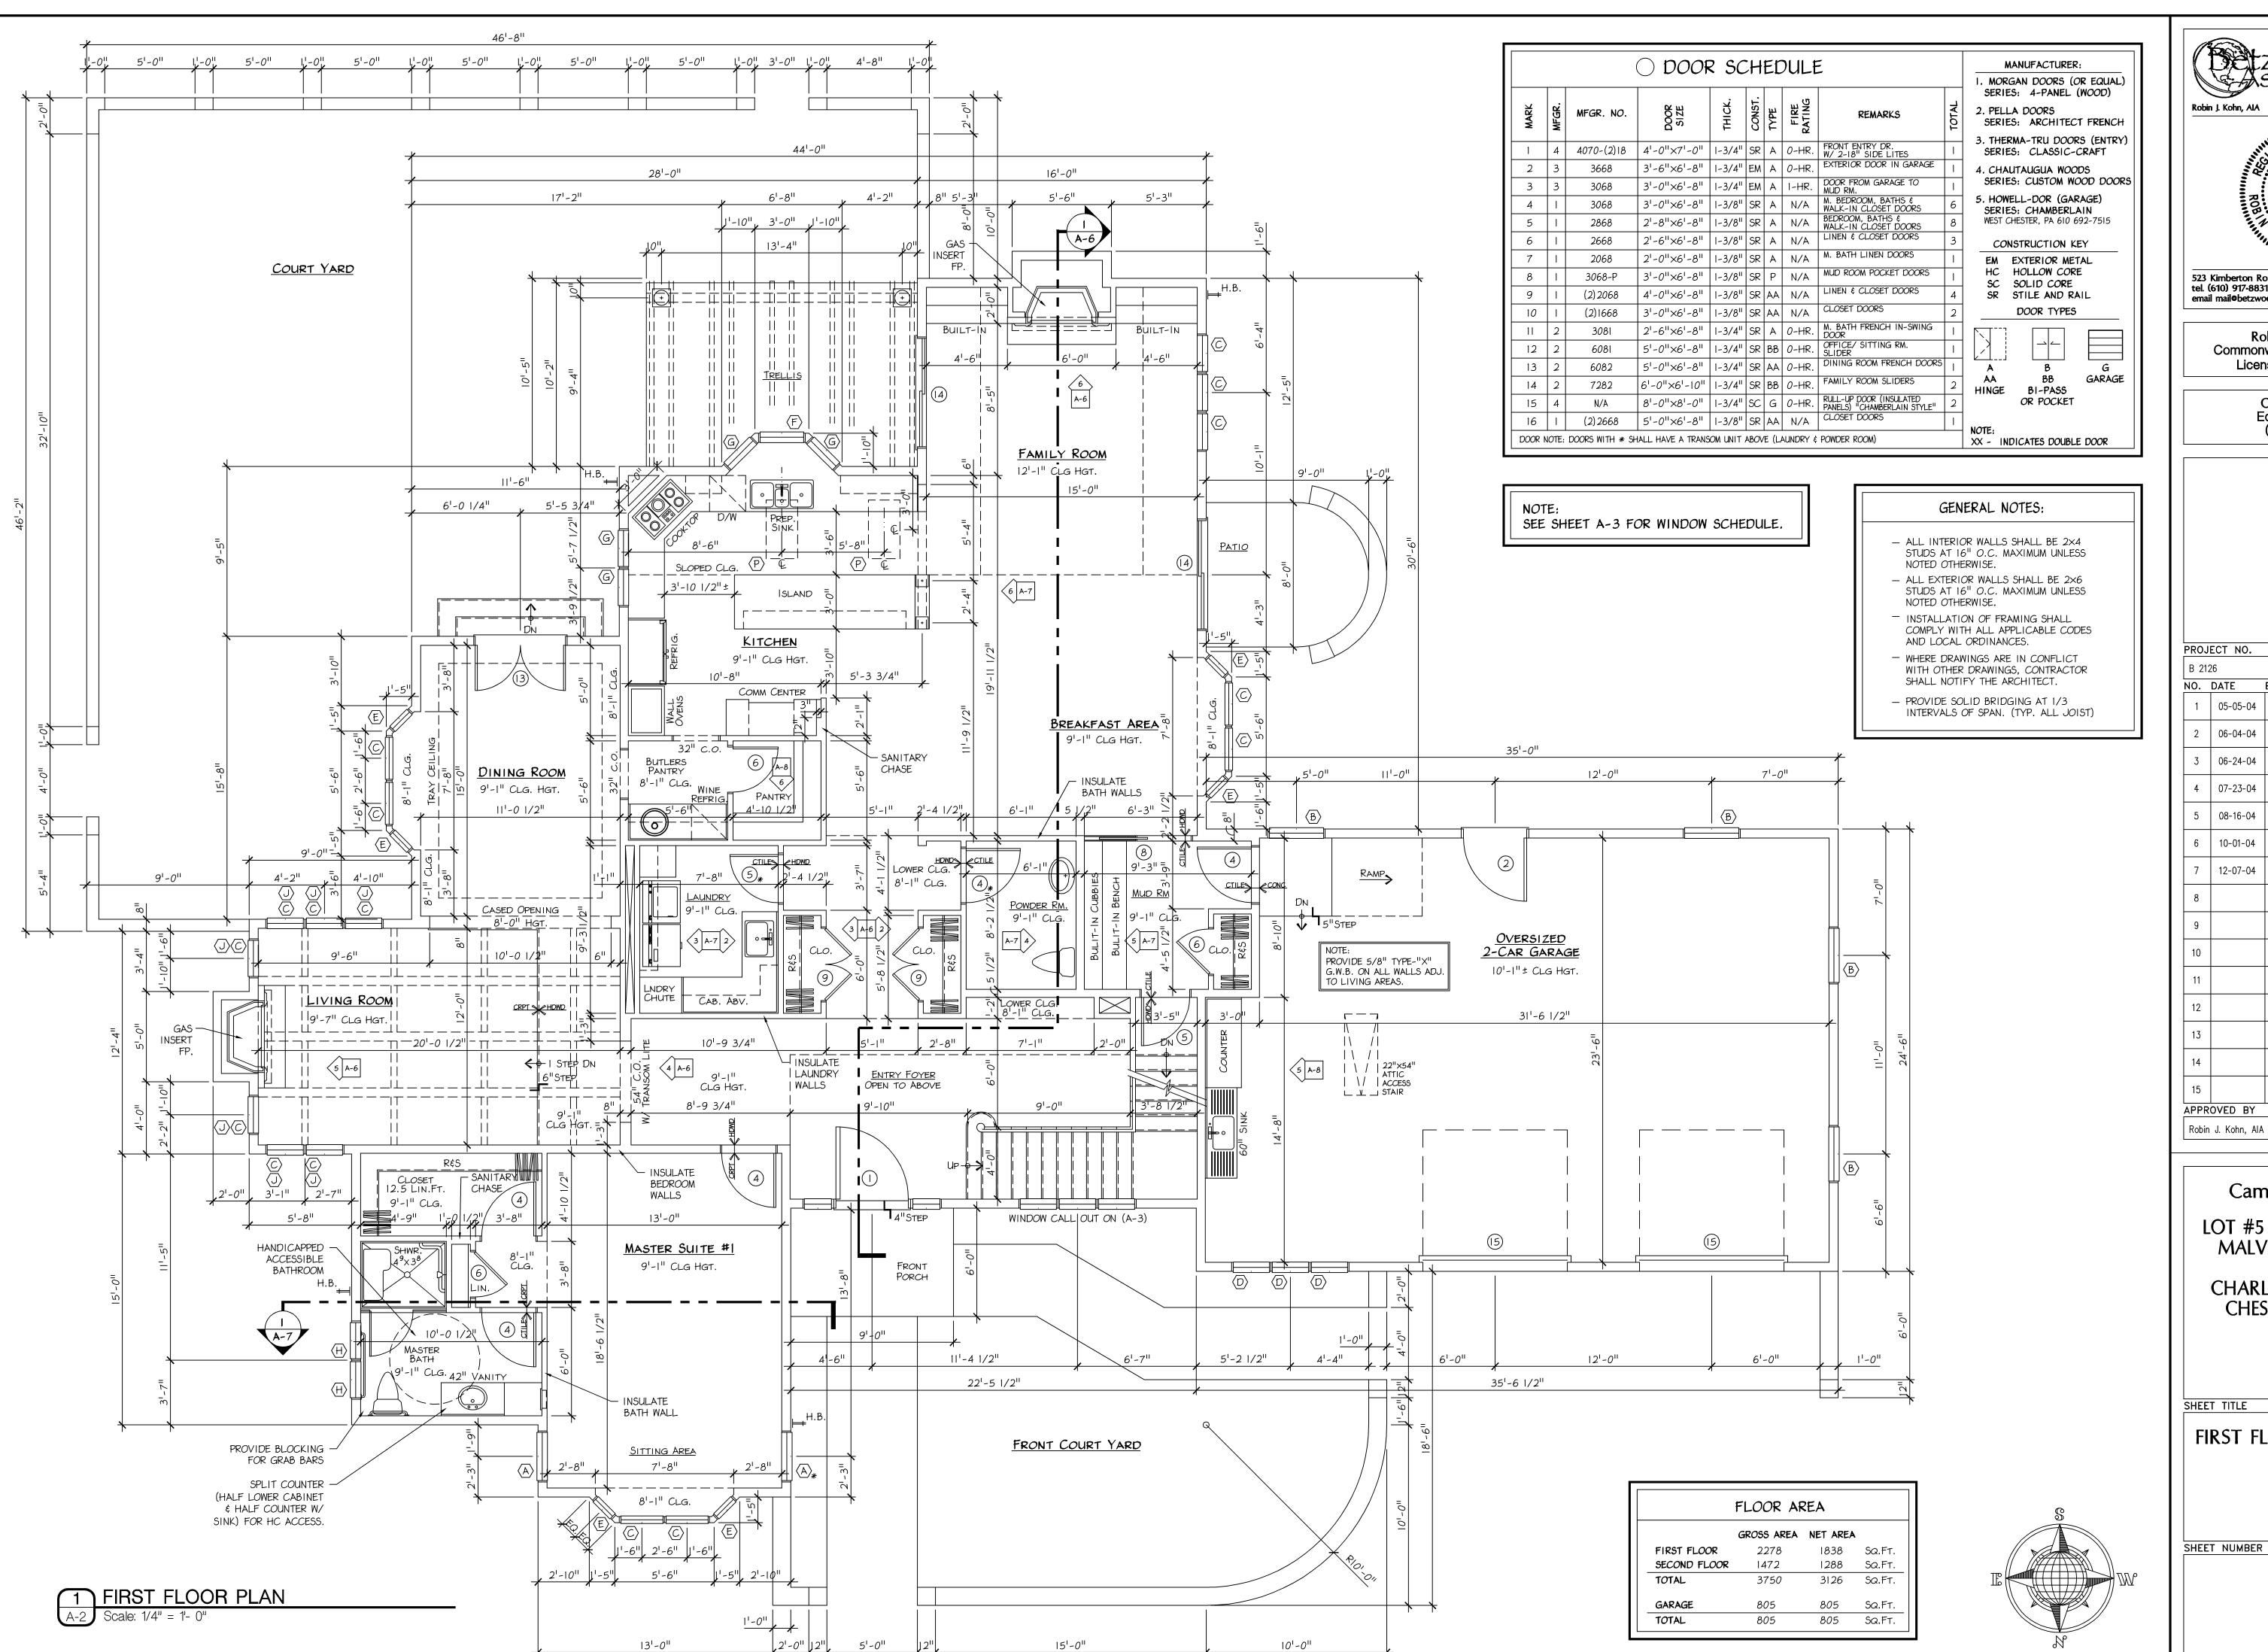

523 Kimberton Road, Suite 11B Phoenixville, PA 19460 tel. (610) 917-8831 fax (610) 917-8836 email mail@betzwood.com http://www.betzwood.com

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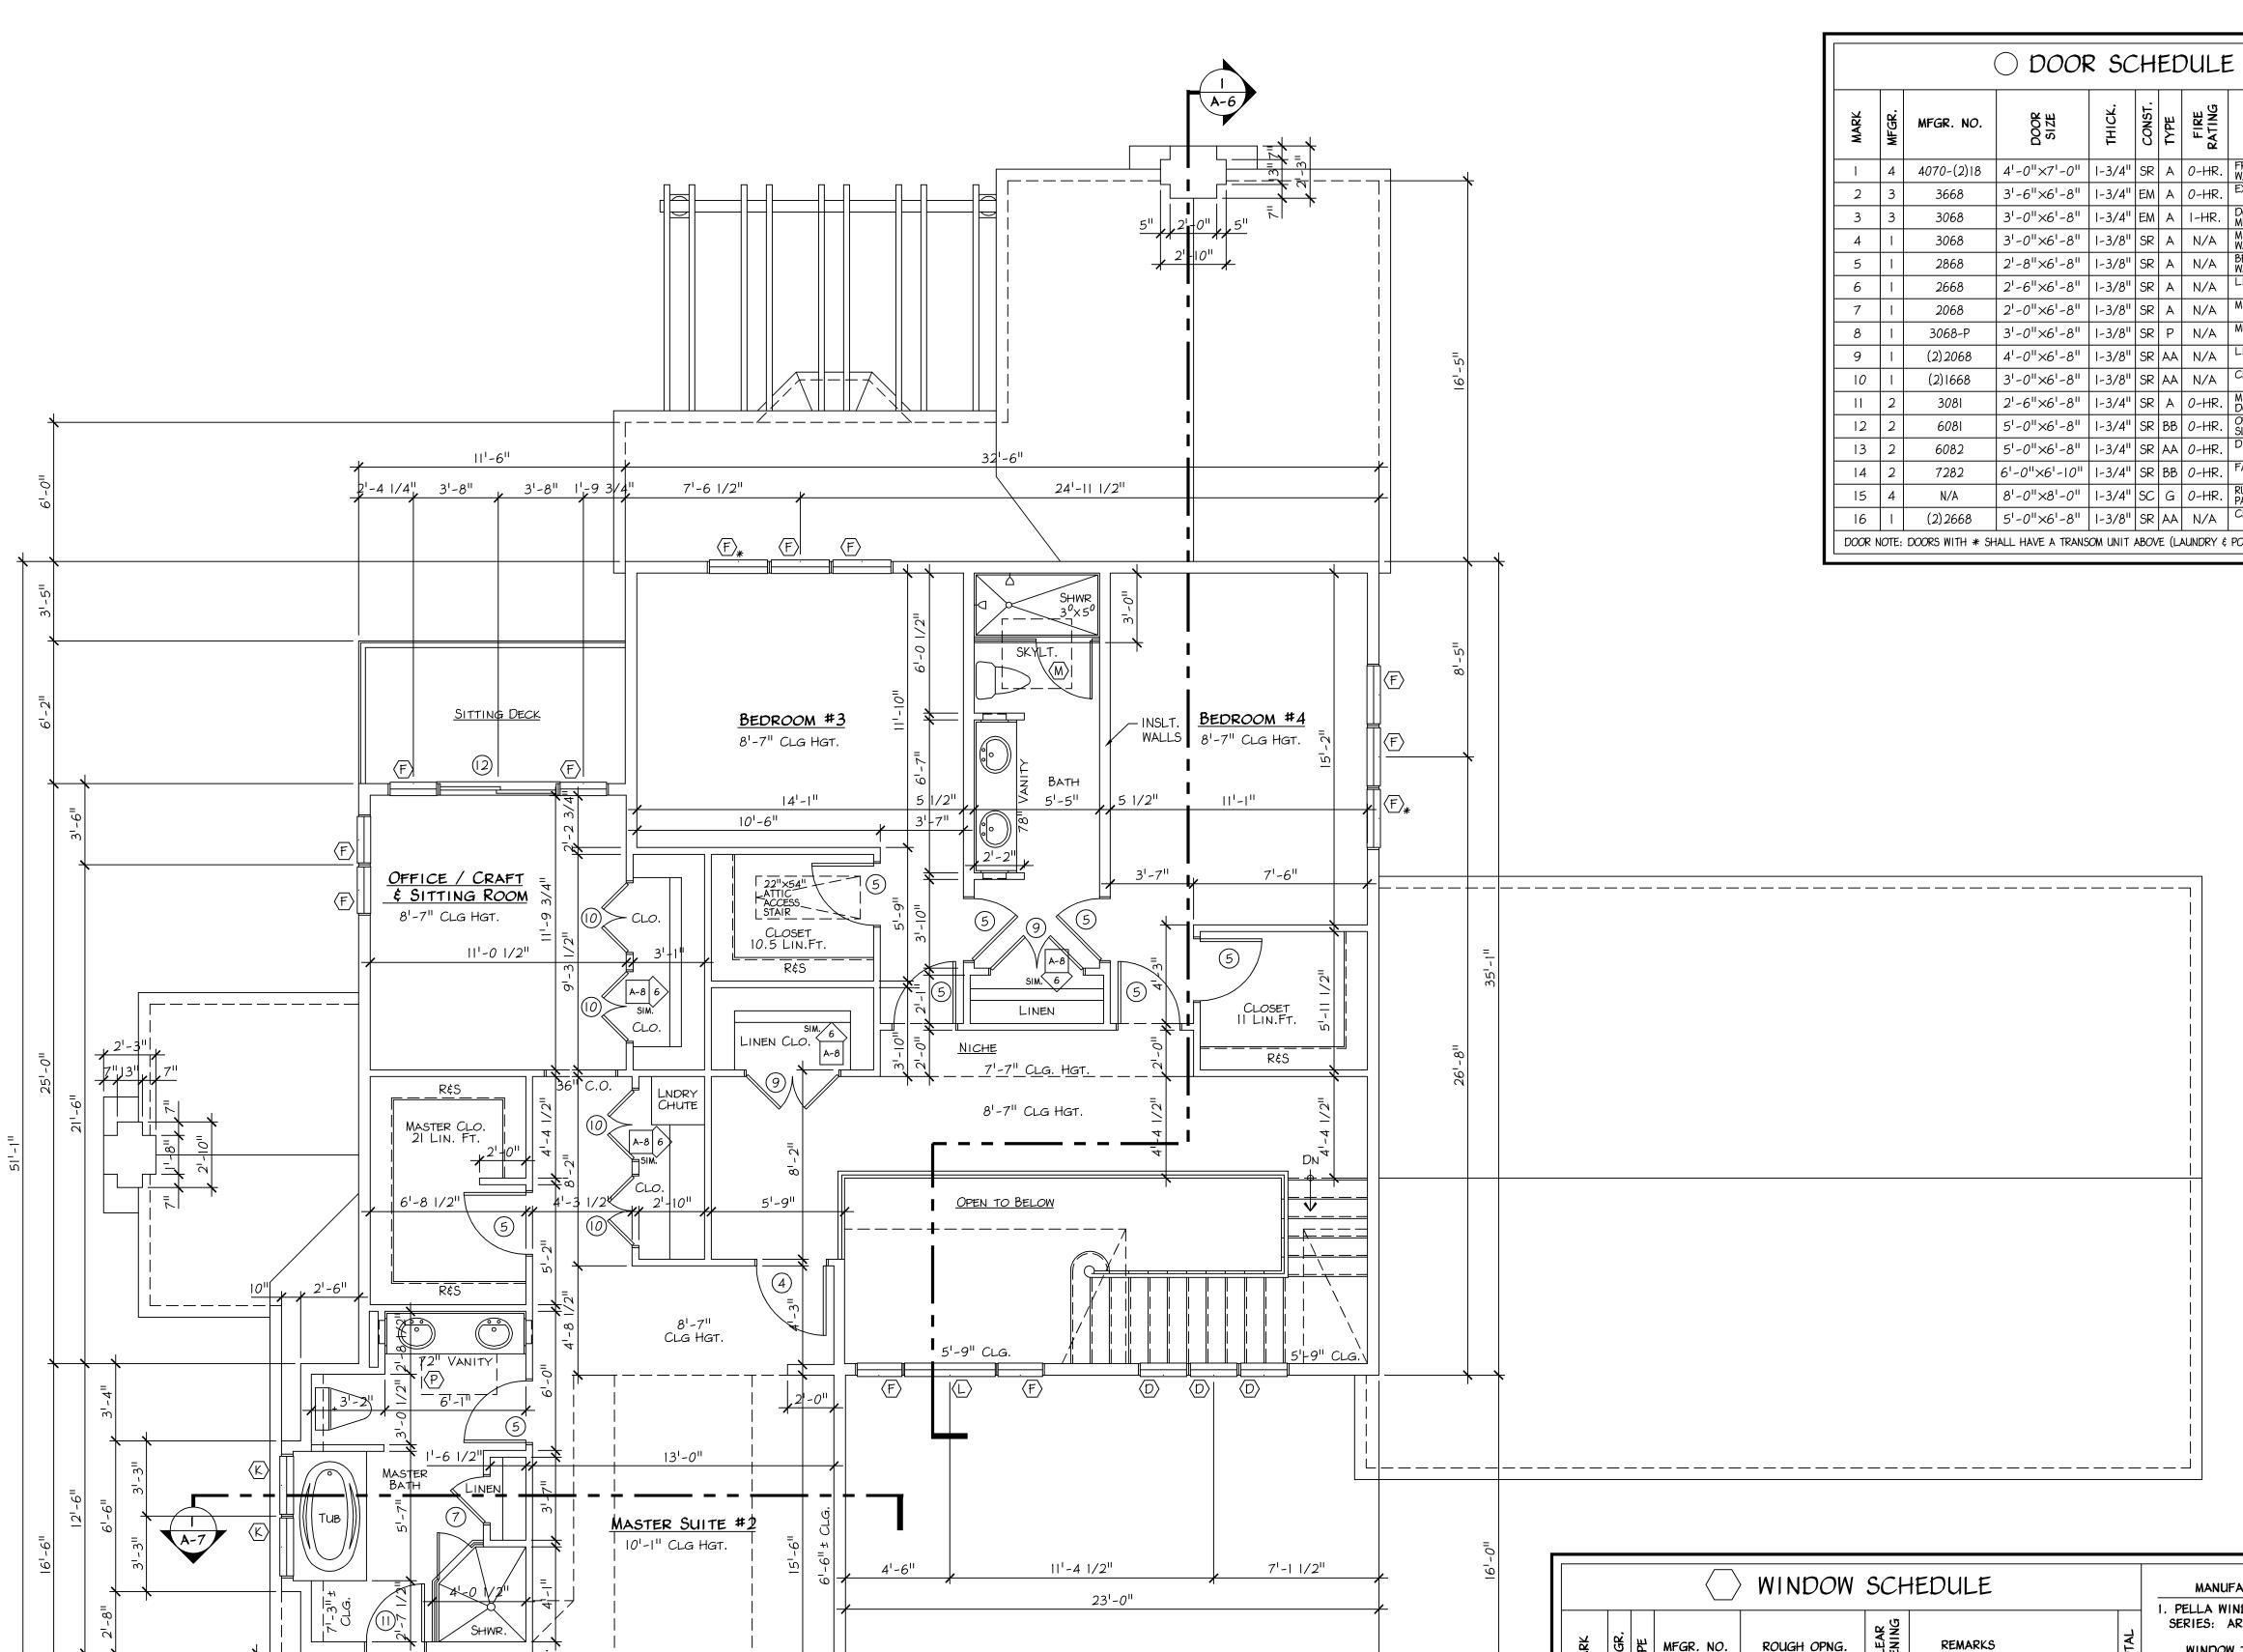
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Camp Residence

LOT #5 DICKSON DRIVE MALVERN, PA 19355

CHARLESTOWN TWP. CHESTER COUNTY

FIRST FLOOR PLAN



23'-0"


		(O DOOF	R SC	H	EĽ	DULE			MANUFACTURER: I. MORGAN DOORS (OR EQUAL)
MARK	MFGR.	MFGR. NO.	DOOR SIZE	THICK.	CONST.	TYPE	FIRE RATING	REMARKS	TOTAL	SERIES: 4-PANEL (WOOD) 2. PELLA DOORS SERIES: ARCHITECT FRENCH 3. THERMA-TRU DOORS (ENTRY)
1	4	4070-(2)18	4'-0"×7'-0"	1-3/4"	SR	Α	0-HR.	FRONT ENTRY DR. W/ 2-18" SIDE LITES	1	SERIES: CLASSIC-CRAFT
2	3	3668	3'-6"×6'-8"	1-3/4"	EM	Α	0-HR.	EXTERIOR DOOR IN GARAGE	1	4. CHAUTAUGUA WOODS
3	3	3068	3'-0"×6'-8"	1-3/4"	EM	А	I-HR.	DOOR FROM GARAGE TO MUD RM.	1	SERIES: CUSTOM WOOD DOORS
4	1	3068	3'-0"×6'-8"	1-3/8"	SR	Α	N/A	M. BEDROOM, BATHS & WALK-IN CLOSET DOORS	6	5. HOWELL-DOR (GARAGE) SERIES: CHAMBERLAIN
5	1	2868	2'-8"×6'-8"	1-3/8"	SR	Α	N/A	BEDROOM, BATHS & WALK-IN CLOSET DOORS	8	WEST CHESTER, PA 610 692-7515
6	1	2668	2'-6"×6'-8"	1-3/8"	SR	Α	N/A	LINEN & CLOSET DOORS	3	CONSTRUCTION KEY
7	1	2068	2'-0"×6'-8"	1-3/8"	SR	Α	N/A	M. BATH LINEN DOORS	1	EM EXTERIOR METAL
8	1	3068-P	3'-0"×6'-8"	1-3/8"	SR	P	N/A	MUD ROOM POCKET DOORS	1	HC HOLLOW CORE SC SOLID CORE
9	1	(2) 2068	4'-0"×6'-8"	1-3/8"	SR	AA	N/A	LINEN & CLOSET DOORS	4	SR STILE AND RAIL
10	1	(2)1668	3'-0"×6'-8"	1-3/8"	SR	AA	N/A	CLOSET DOORS	2	DOOR TYPES
11	2	3081	2'-6"×6'-8"	1-3/4"	SR	Α	0-HR.	M. BATH FRENCH IN-SWING DOOR	1	
12	2	6081	5'-0"×6'-8"	1-3/4"	SR	ВВ	0-HR.	OFFICE/ SITTING RM. SLIDER	1	
13	2	6082	5'-0"×6'-8"	1-3/4"	SR	AA	0-HR.	DINING ROOM FRENCH DOORS	1	A B G
14	2	7282	6'-0"×6'-10"	1-3/4"	SR	ВВ	0-HR.	FAMILY ROOM SLIDERS	2	AA BB GARAGE HINGE BI-PASS
15	4	N/A	8'-0"×8'-0"	1-3/4"	SC	G	0-HR.	RULL-UP DOOR (INSULATED PANELS) "CHAMBERLAIN STYLE"	2	OR POCKET
16	1	(2) 2668	5'-0"×6'-8"	1-3/8"	SR	AA	N/A	CLOSET DOORS	1	NOTE:
DOOR N	OTE:	DOORS WITH * SH	ALL HAVE A TRANS	OM UNIT	ABOV	E (L/	AUNDRY \$	POWDER ROOM)		XX - INDICATES DOUBLE DOOR


GENERAL NOTES:

- ALL INTERIOR WALLS SHALL BE 2×4 STUDS AT 16" O.C. MAXIMUM UNLESS NOTED OTHERWISE.
- ALL EXTERIOR WALLS SHALL BE 2×6 STUDS AT 16" O.C. MAXIMUM UNLESS NOTED OTHERWISE.
- INSTALLATION OF FRAMING SHALL COMPLY WITH ALL APPLICABLE CODES AND LOCAL ORDINANCES.
- WHERE DRAWINGS ARE IN CONFLICT WITH OTHER DRAWINGS, CONTRACTOR SHALL NOTIFY THE ARCHITECT.
- PROVIDE SOLID BRIDGING AT 1/3 INTERVALS OF SPAN. (TYP. ALL JOIST)

FLOOR AREA								
	GROSS AREA	NET AREA						
FIRST FLOOR	2278	1838	SQ.FT.					
SECOND FLOOR	1472	1288	Sa.Ft.					
TOTAL	3750	3126	Sa.Ft.					
GARAGE	805	805	Sa.Ft.					
TOTAL	805	805	Sa.Ft.					

				WINDOW	SCH	HEDULE		MANUFACTURER: 1. PELLA WINDOWS
MARK	MFGR.	TYPE	MFGR. NO.	ROUGH OPNG.	CLEAR OPENING	TOTAL	SERIES: ARCHITECT SERIES WINDOW TYPE KEY	
Α	1	CA	 2971	2 ¹ -5 3/4"×5 ¹ -11 3/4"		FIRST FLOOR FAMILY RM	2	A ARCHED AW AWNING
В	1	CA	2965	2 ¹ -5 3/4"×5 ¹ -5 3/4"	8.50	FIRST FLOOR	4	B BASEMENT CA CASEMENT
С	1	CA	2571	2'-1 3/4"×5'-11 3/4"	6.50		16	DH DOUBLE HUNG
D	1	CA	2565	2'-1 3/4"×5'-5 3/4"	8.40	FIRST FLOOR	9	SK SKYLIGHT P PICTURE WINDOW
E	1	СА	1771	l'-5 3/4"×5'-11 3/4"	2.70	SECOND FLOOR	6	T TRANSOM
F	1	CA	2953	2'-5 3/4"×4'-5 3/4"	6.80	SECOND FLOOR	15	GLAZING FRAME
G	1	CA	2553	2 ¹ -1 3/4"×4 ¹ -5 3/4"	6.80	SECOND FLOOR -	4	□ SINGLE □ ALUMINUM
Н	1	CA	2153	1'-9 3/4"×4'-5 3/4"	3.30	SECOND FLOOR	2	■ DOUBLE ■ WOOD ■ LOW-E □ VINYL
J	1	Т	2517	2'-1 3/4"×1'-5 3/4"	0.0	KITCHEN, POWDER RM. HALL BATH & M. BATH	7	☐ TRIPLE ☐ OTHER
K	1	CA	2959	2 ¹ -5 3/4"×4 ¹ -11 3/4"	7.60	SECOND FLOOR BEDROOM #4	5	HARDWARE CLADDING
L	1	Р	4753	3 ¹ -11 3/4"×4 ¹ -5 3/4"	0.0	SECOND FLOOR BEDROOM #4	1	■ WHITE ■ ALUMINUM □ BRASS □ WOOD
М	1	SK	4547	3'-8 7/8"×3'-11"	N/A	HALL BATHROOM SKYLIGHT	1	□ NICKEL □ VINYL
N	1	Т	2525	2'-1 3/4"×2'-1 3/4"	N/A	BASEMENT STAIRS WINDOW	2	☐ BRONZE ☐ OTHER
P	1	SK	2239	1'-9 1/4"×3'-3 1/16"	N/A	KITCHEN & M BATH SKYLIGHT	3	NOTE:
a	1	В	2517	2'-11 3/4"×1'-5 3/4"	2.80	BASEMENT WINDOW		* DENOTES EGRESS WINDOW

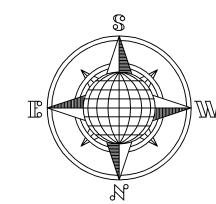

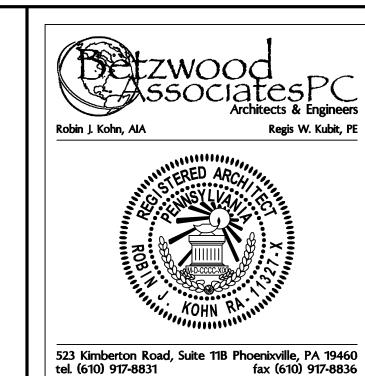

email mail@betzwood.com http://www.betzwood.com

Robin J. Kohn, AIA Commonwealth of Pennsylvania License No. RA-11327-X

> Contact Person: Edward M. Happ (610) 917-8831

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Robi	n J. Kohn, Al <i>A</i>	١	December 07, 2004

Camp Residence

LOT #5 DICKSON DRIVE MALVERN, PA 19355

CHARLESTOWN TWP.
CHESTER COUNTY

SHEET TITLE

SECOND FLOOR PLAN

SHEET NUMBER


1 SECOND FLOOR PLAN


10'-4"

7'-0"

471-411

14'-0"

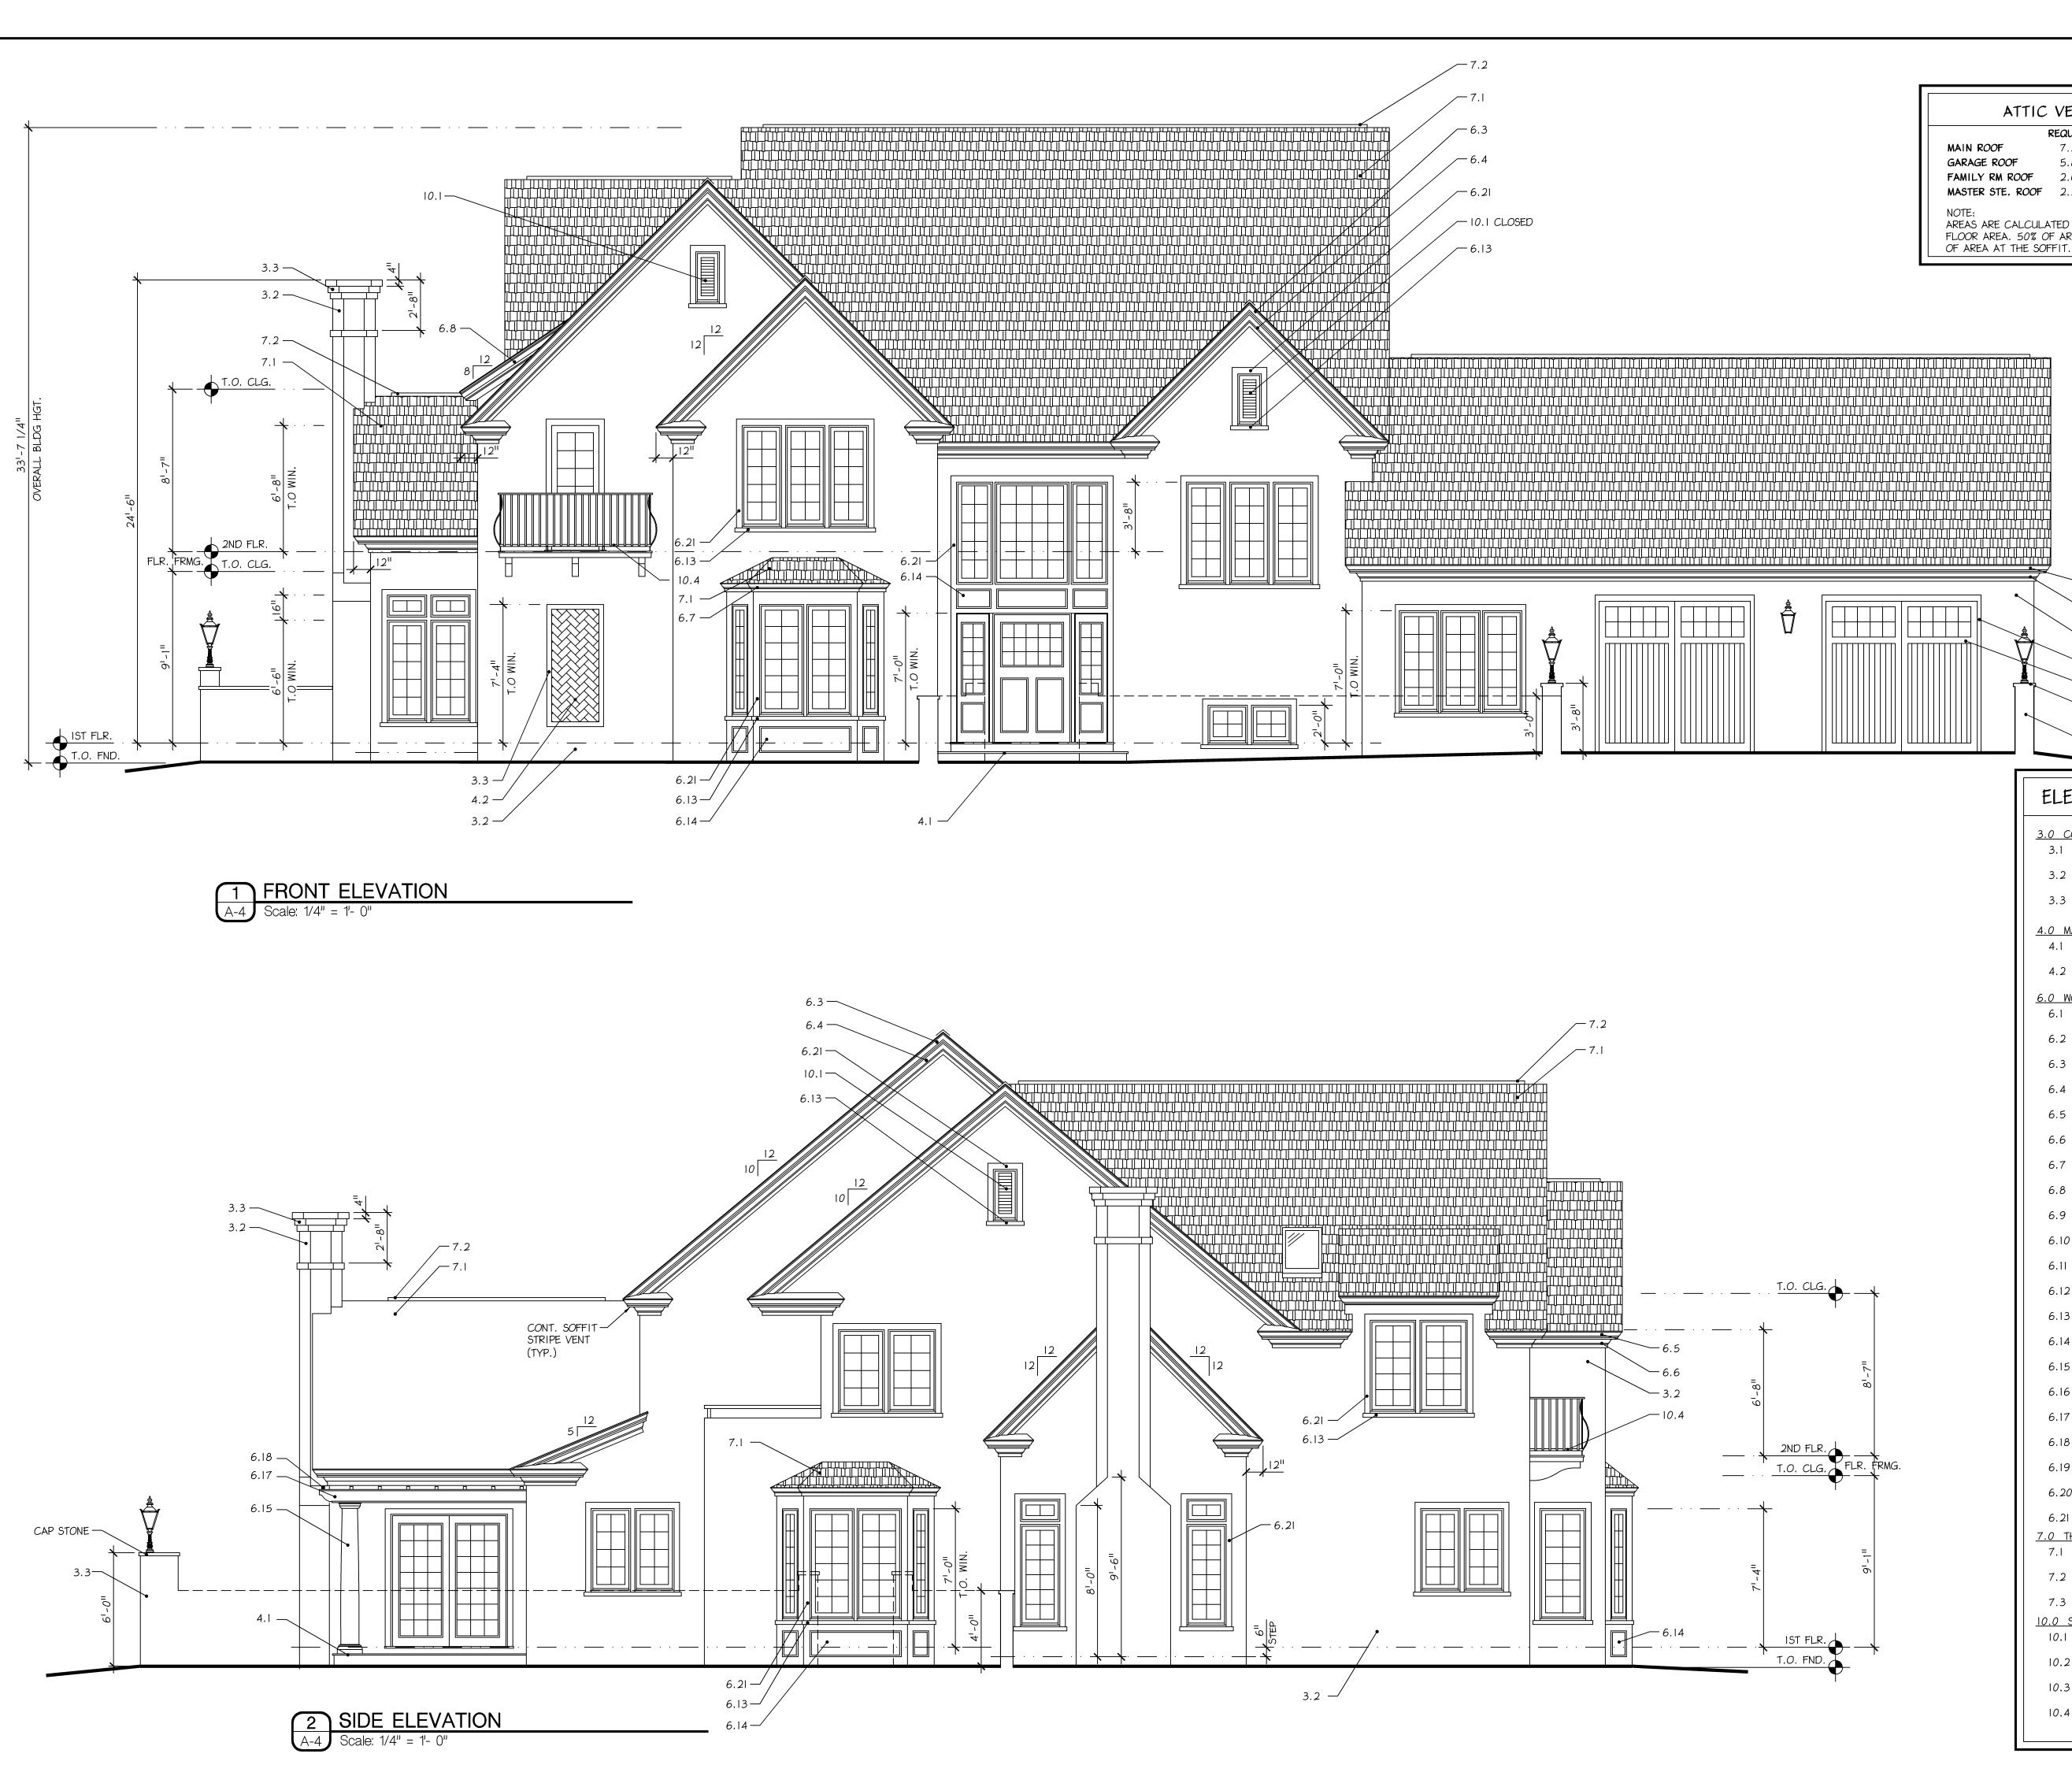

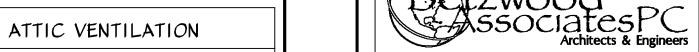



8.25 Sa.Ft. 2.64 3.50 MASTER STE. ROOF 2.32 5.00 Sq.Ft.

ELEVATION KEYNOTES

DRYVIT FINISHING SYSTEM 3.3 CEMENT STUCCO OR DRYVIT

EP HENERY - OLD TOWNE COBBLE

FINISHING SYSTEM / BUILD-UP TRIM

COLOR TO BE CHOSEN BY OWNER

6.1 BEADED VINYL HORIZONTAL SIDING CERTAINTEED - CAROLINA BEADED

6.3 GABLE END / BARGEBOARD TRIM FYPON - MOLDING (CROWN)

FYPON - MOLDING (CROWN)

FYPON - MOLDING (CROWN) 6.7 BAY / DORMER FASCIA TRIM FYPON - MOLDING (CROWN) 6.8 BAY / DORMER GABLE END TRIM FYPON - MOLDING (CROWN)

GLEN GARY - HERRINGBONE PATTERN

3.0 CONCRETE

<u>4.0 MASONRY</u>

3.1 CONCRETE PAVERS

3.2 CEMENT STUCCO OR

4.1 ASHLAR FLAGSTONE

6.0 WOODS AND PLASTICS

6.2 SHIP-LAP VINYL SIDING CERTAINTEED

6.4 GABLE END / FREEZE TRIM FYPON - MOLDING (CROWN)

6.6 FASCIA / FREEZE TRIM

6.9 WINDOW / DOOR HEADER FYPON - MOLDING 6.10 DORMER HEAD TRIM FYPON - DORMER

6.11 WINDOW / DOOR SIDE TRIM FYPON - DORMER

FYPON - RAISED PANEL 6.13 WINDOW SILL EXTENSIONS

FYPON - RAISED PANEL 6.15 COLUMN - PLAIN TAPERED 12" DIA. ROUND - RED CEDAR

FIBERGLASS OR CEMENTITIOUS

RAILING, BALUSTERS & POSTS 6.20 PRESSURE TREATED 4×4 COLUMN

7.0 THERMAL & MOISTURE PROTECTION

FYPON - MOLDING

6.17 2×8 JOIST - DECORATIVE RED CEDAR 6.18 2×2 PURLIN

6.19 PRESSURE TREATED WOOD

\$ 2×4 MID-RAIL 6.21 FYPON MOLDING / I X TRIM

RED CEDAR

6.12 WINDOW SHUTTERS

6.14 WINDOW PANELS

6.16 LATTICE

4.2 VENEER BRICK

6.5 FASCIA TRIM

AREAS ARE CALCULATED BY 1/150 OF THE ATTIC FLOOR AREA. 50% OF AREA AT THE RIDGE, 50%

Regis W. Kubit, PE

tel. (610) 917-8831 fax (610) 917-8836 email mail@betzwood.com http://www.betzwood.com

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Camp Residence

LOT #5 DICKSON DRIVE MALVERN, PA 19355

CHARLESTOWN TWP. CHESTER COUNTY

SHEET TITLE

ELEVATIONS

7.1 ROOF SHINGLES - ARCHITECTURAL STYLE (30 YR. WARRANTY) 7.2 RIDGE VENT - BENJAMIN OBDYKE

XTRACTOR VENT - SERIES: X18

7.3 FLASHING - 160Z COPPER 10.0 SPECIALTIES

10.1 GABLE END LOUVER FYPON - OPEN W/ SCREEN (U.N.O.)

10.2 8×8 GARAGE DOORS HOWELL-DOR - CUSTOM

SEE PLAN FOR SIZE

10.3 FIBERGLASS SCREENING SET IN ALUM. OR WOOD FRAME 10.4 WROUGHT IRON BALCONY


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6.2l —

3.2 —

2 SIDE ELEVATION



Robin J. Kohn, AIA Commonwealth of Pennsylvania License No. RA-11327-X

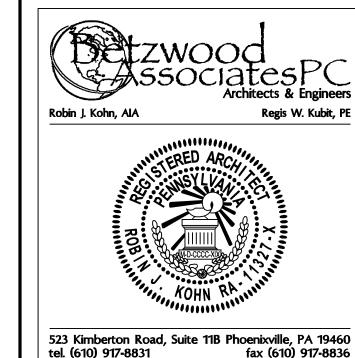email mail@betzwood.com http://www.betzwood.com

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Camp Residence

LOT #5 DICKSON DRIVE MALVERN, PA 19355

CHARLESTOWN TWP. CHESTER COUNTY

SHEET TITLE

ELEVATIONS

SHEET NUMBER

10.2 8×8 GARAGE DOORS


HOWELL-DOR - CUSTOM 10.3 FIBERGLASS SCREENING


10.4 WROUGHT IRON BALCONY SEE PLAN FOR SIZE


SET IN ALUM. OR WOOD FRAME


A-5


7 RE

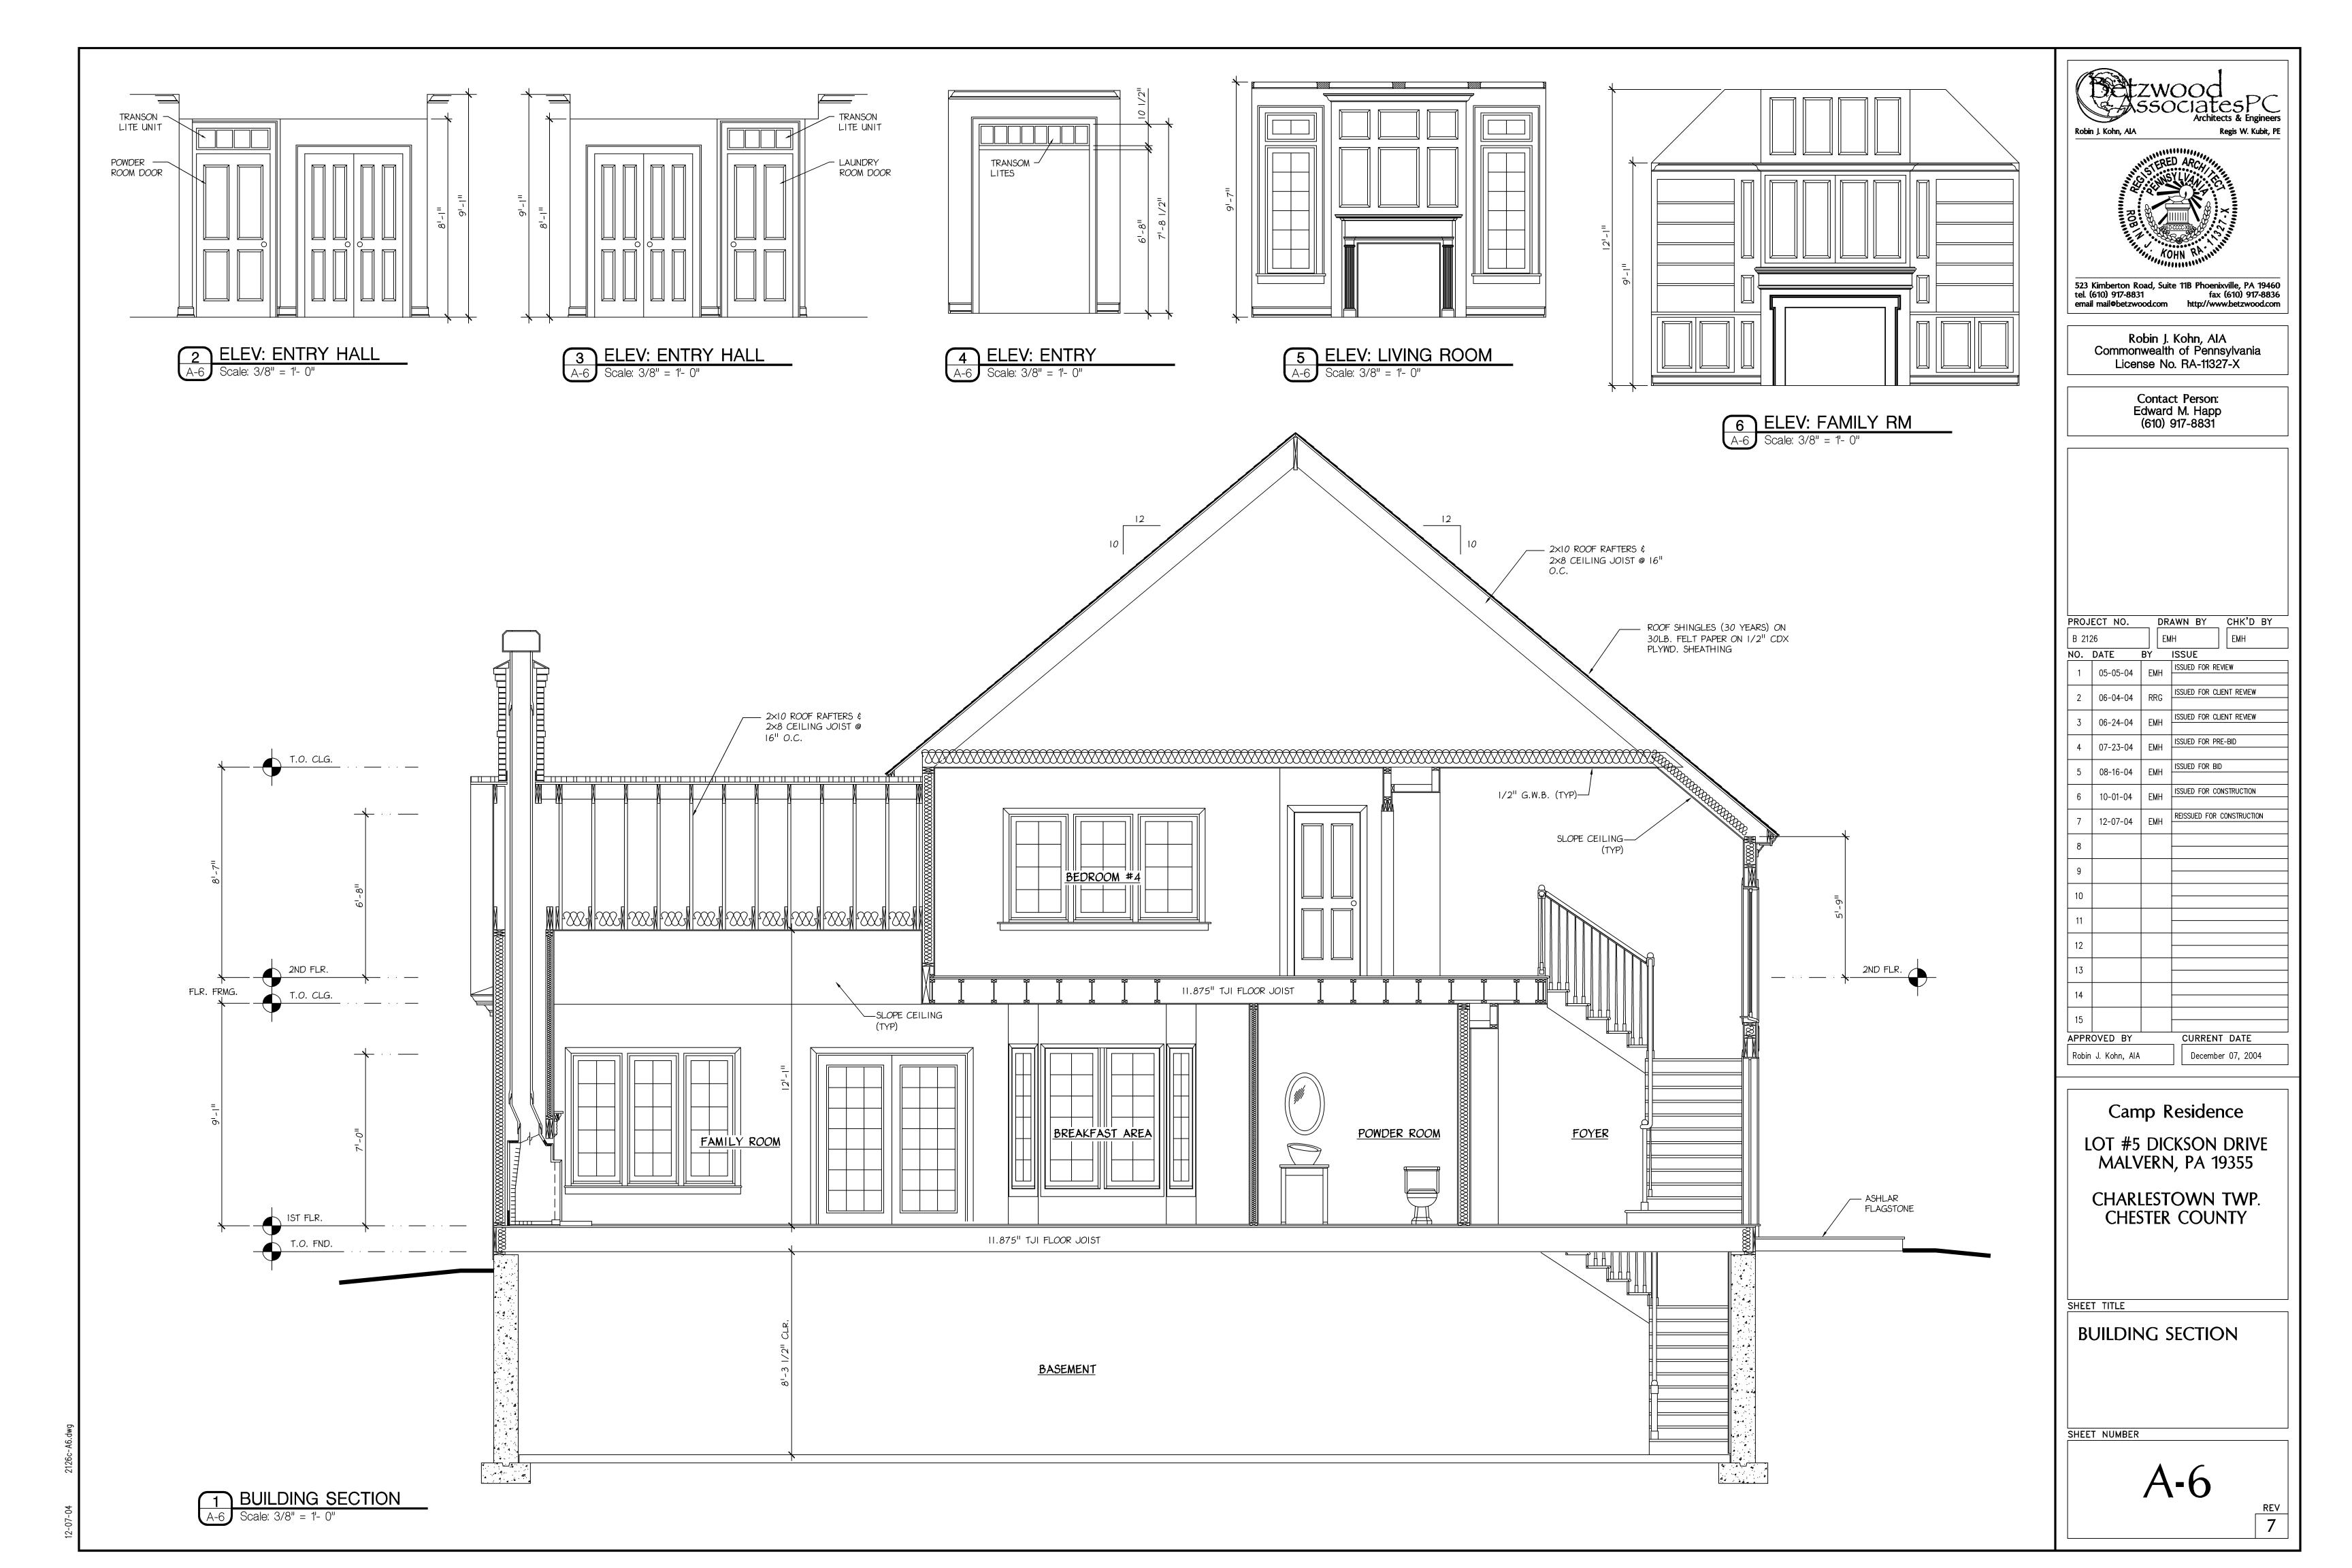

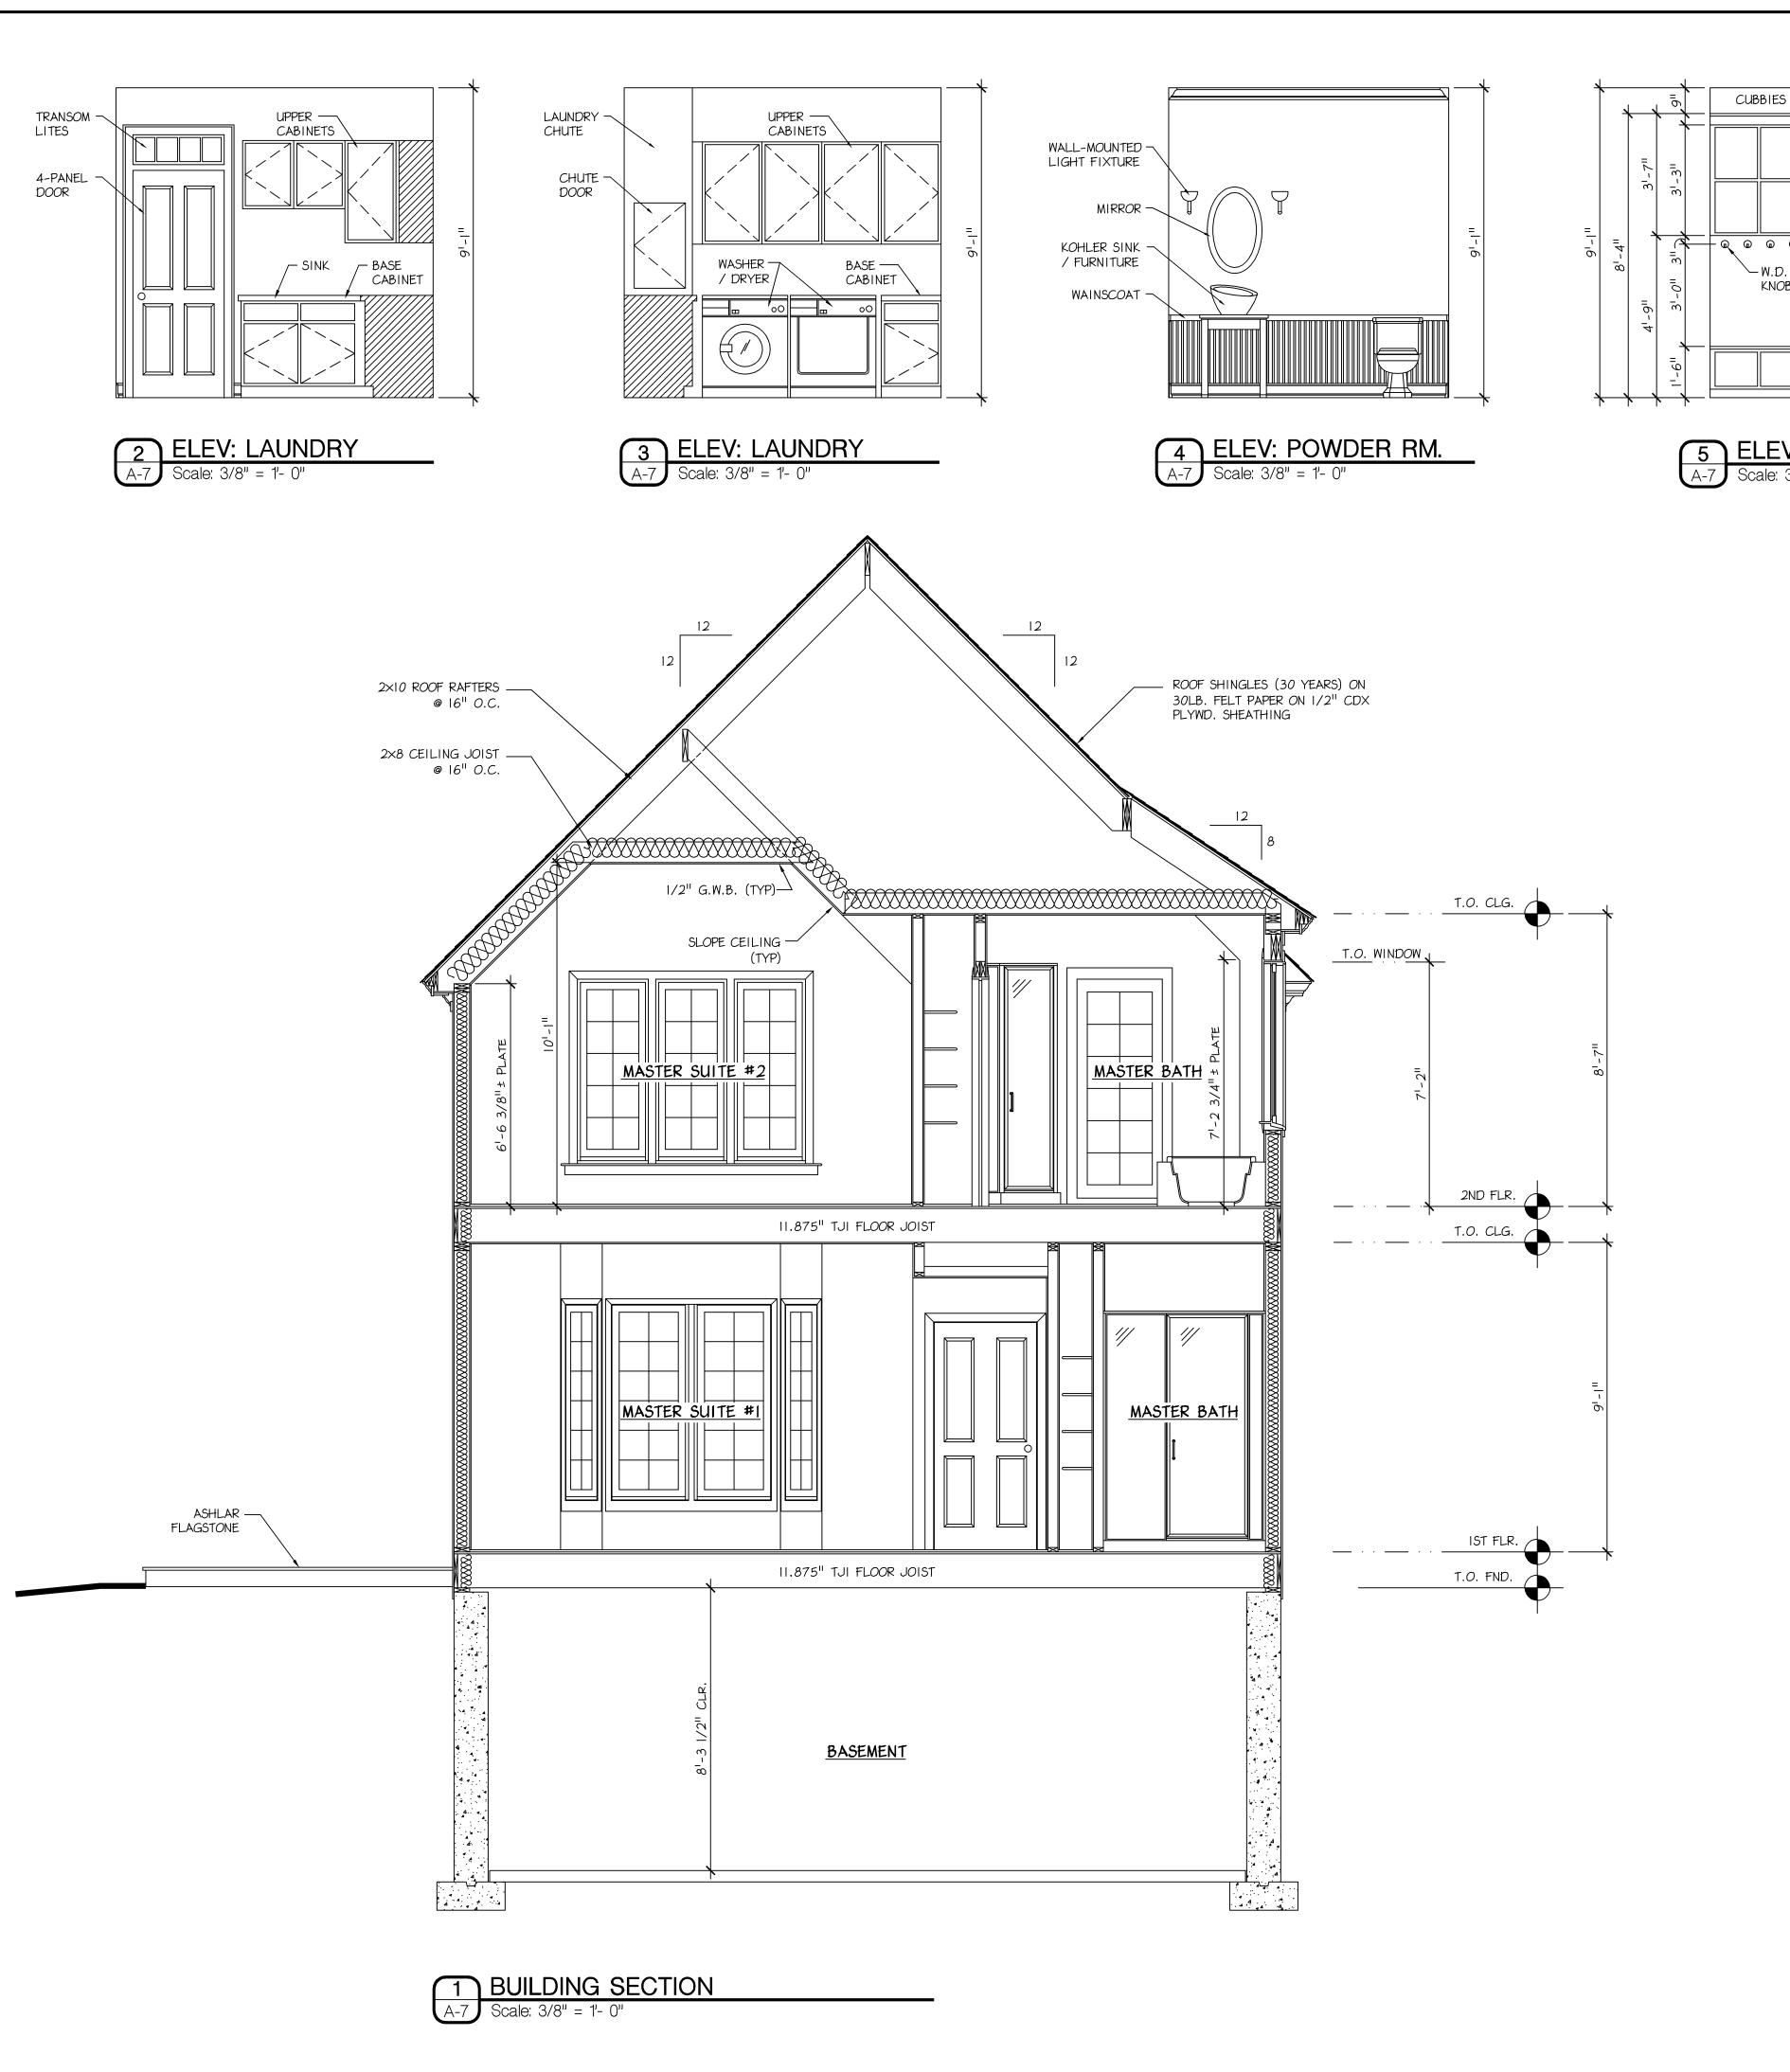

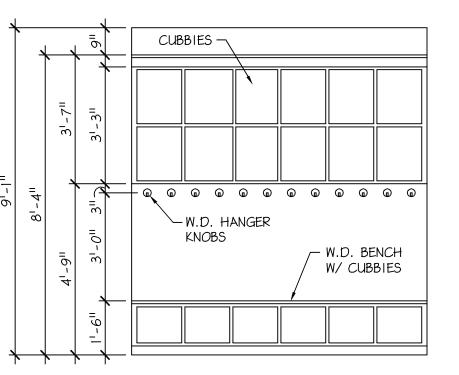

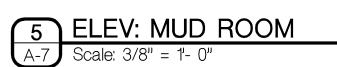


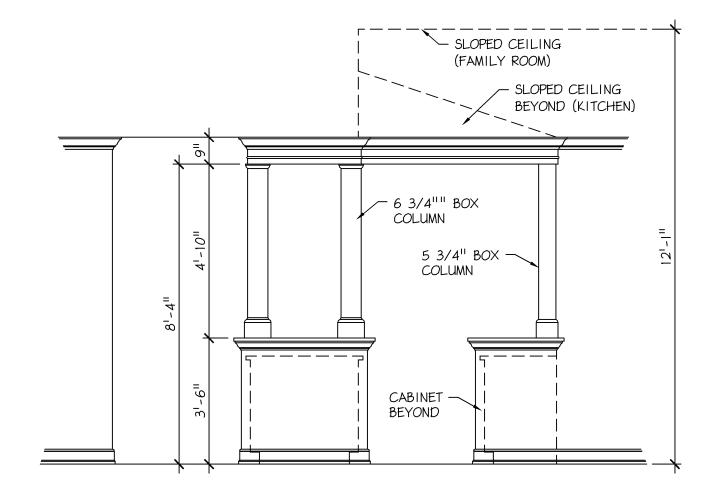


6 ELEV: KITCHEN

A-7 Scale: 3/8" = 1'- 0"

	LEVEL	FLOOR	WALL	WAINSCOAT	CHAIR RAIL	CROWN MOLD	EILING				MA	TE	ERIAL C	01	DE
SPACE	当	匠	Ž	¥	7	8	2	HEIGHT	REMARKS	Fl	_R. / BASE		WALL		CEILING
FOYER	IST	2	Α	•		•	1	9'-1"	CLG. HEIGHT VARIES	1	CPT / WD	А	G.W.B.	1	G.W.B.
LIVING ROOM	IST	2	Α	•			1	9'-7"	COFFERED CEILING SEE MOLDING & TRIM DETAILS	2	H WD / WD	В	MR G.W.B.	2	MR G.W.B.
DINING ROOM	IST	2	А		•	•	1	9'-1"	TRAY CEILING	3	CT / WD	С	CT	3	CT
KITCHEN	IST	3	А				1	9'-1"		4	CT / CT	D	WD PANEL	4	
FAMILY ROOM	IST	1	А			•	1	12'-1"	SLOPING CEILING	5	VNYL / WD	E	BRICK	5	
BREAKFAST ROOM	IST	2	А			•	1	9'-1"		6	CONC.	F	5/8" 'X' GWB	6	5/8" 'X' GW
POWDER ROOM	IST	3	А	•		•	1	9'-1"		7	SUBFLR.	G	UNFINISHED	7	UNFINISHED
MUD ROOM	IST	3	А	•			1	9'-1"		8	P.T. WD	Н	SIDING	8	WD T\$G
GARAGE	IST	6	A¢F				1	10'-1"±	WALLS ADJACENT TO LIVING SPACE SHALL FIRE RATED		M.A	TER	IAL GLOSSARY		
LAUNDRY	IST	3	А				1	9'-1"		l ,	 CPT		CARPET	_	
BUTLERS PANTRY	IST	2	А	•			1	8'-1"		(CT		CERAMIC TILE		
MASTER SUITE #1	IST	2	А			•	1	9'-1"		I	CONC. G.W.B.		CONCRETE GYPSUM WALL	BO	ARD
MASTER BATH	IST	3	В				1	9'-1"		+	H WD		HARDWOOD FL	.00F	2
MASTER CLOSET	IST	2	А				1	9'-1"		I	MR.G.W.B. T		MOISTURE RES	1517	ANT G.W.B.
MASTER SUITE #2	2ND	1	А			•	1	10'-1"		I	√T ND.		SHEET VINYL WOOD	TILE	:
MASTER BATH	2ND	3	В				1	8'-7"	SLOPING CEILING		ND. ND T\$G		WOOD TONGUE	ξ ξ (GROOVE
MASTER CLOSET	2ND	1	А				1	8'-7"							
OFFICE / CRAFT	2ND	2	А				1	8'-7"							
BEDROOM #3	2ND	1	Α				1	8'-7"							

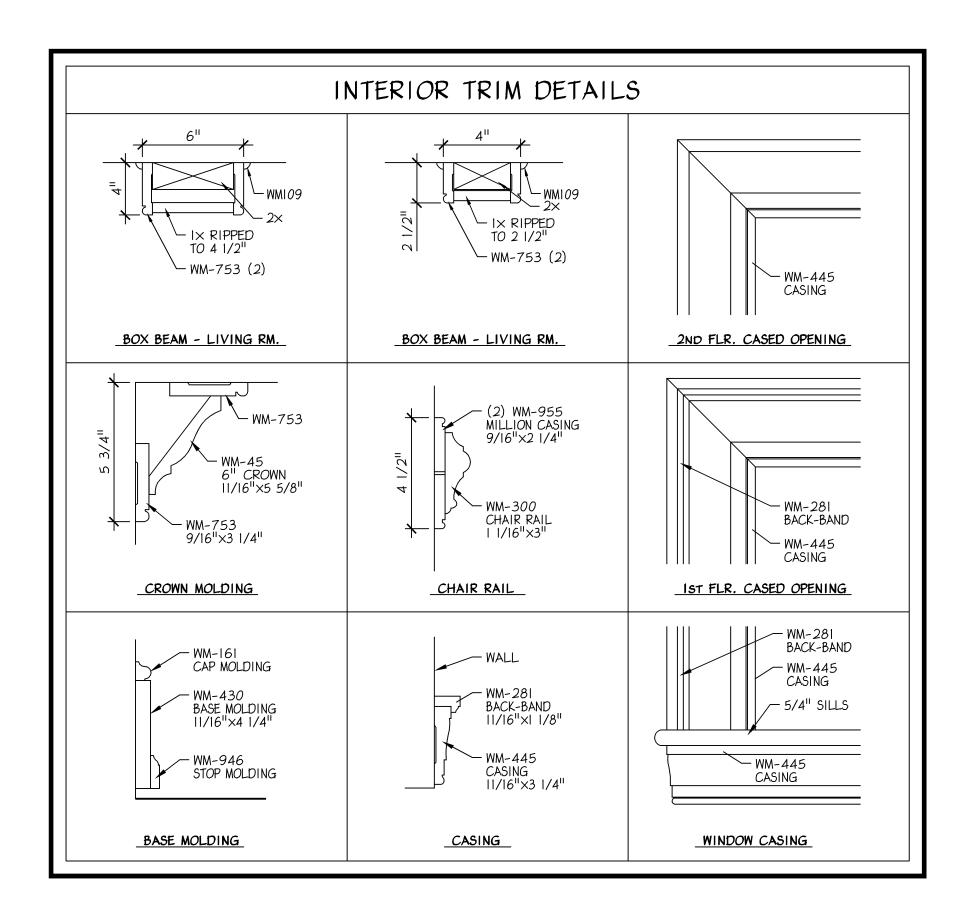

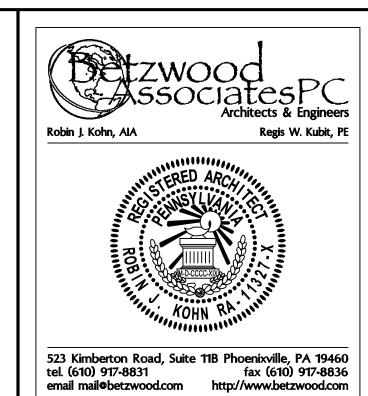

Robin J. Kohn, AIA Commonwealth of Pennsylvania License No. RA-11327-X

> Contact Person: Edward M. Happ (610) 917-8831

PROJ	IECT NO.	DR	AWN BY CHK'D BY			
B 21	26	EI	MH EMH			
NO.	DATE	BY	ISSUE			
1	05-05-04	EMH	ISSUED FOR REVIEW			
2	06-04-04	RRG	ISSUED FOR CLIENT REVIEW			
3	06-24-04	ЕМН	ISSUED FOR CLIENT REVIEW			
4	07-23-04	EMH	ISSUED FOR PRE-BID			
5	08-16-04	EMH	ISSUED FOR BID			
6	10-01-04	EMH	ISSUED FOR CONSTRUCTION			
7	12-07-04	EMH	REISSUED FOR CONSTRUCTION			
8						
9						
10						
11						
		1				
12						
13						
14						
15						
APPR	OVED BY	1	CURRENT DATE			

Camp Residence

LOT #5 DICKSON DRIVE MALVERN, PA 19355

CHARLESTOWN TWP. CHESTER COUNTY


SHEET TITLE

BUILDING SECTION

SHEET NUMBER

A-7

REV

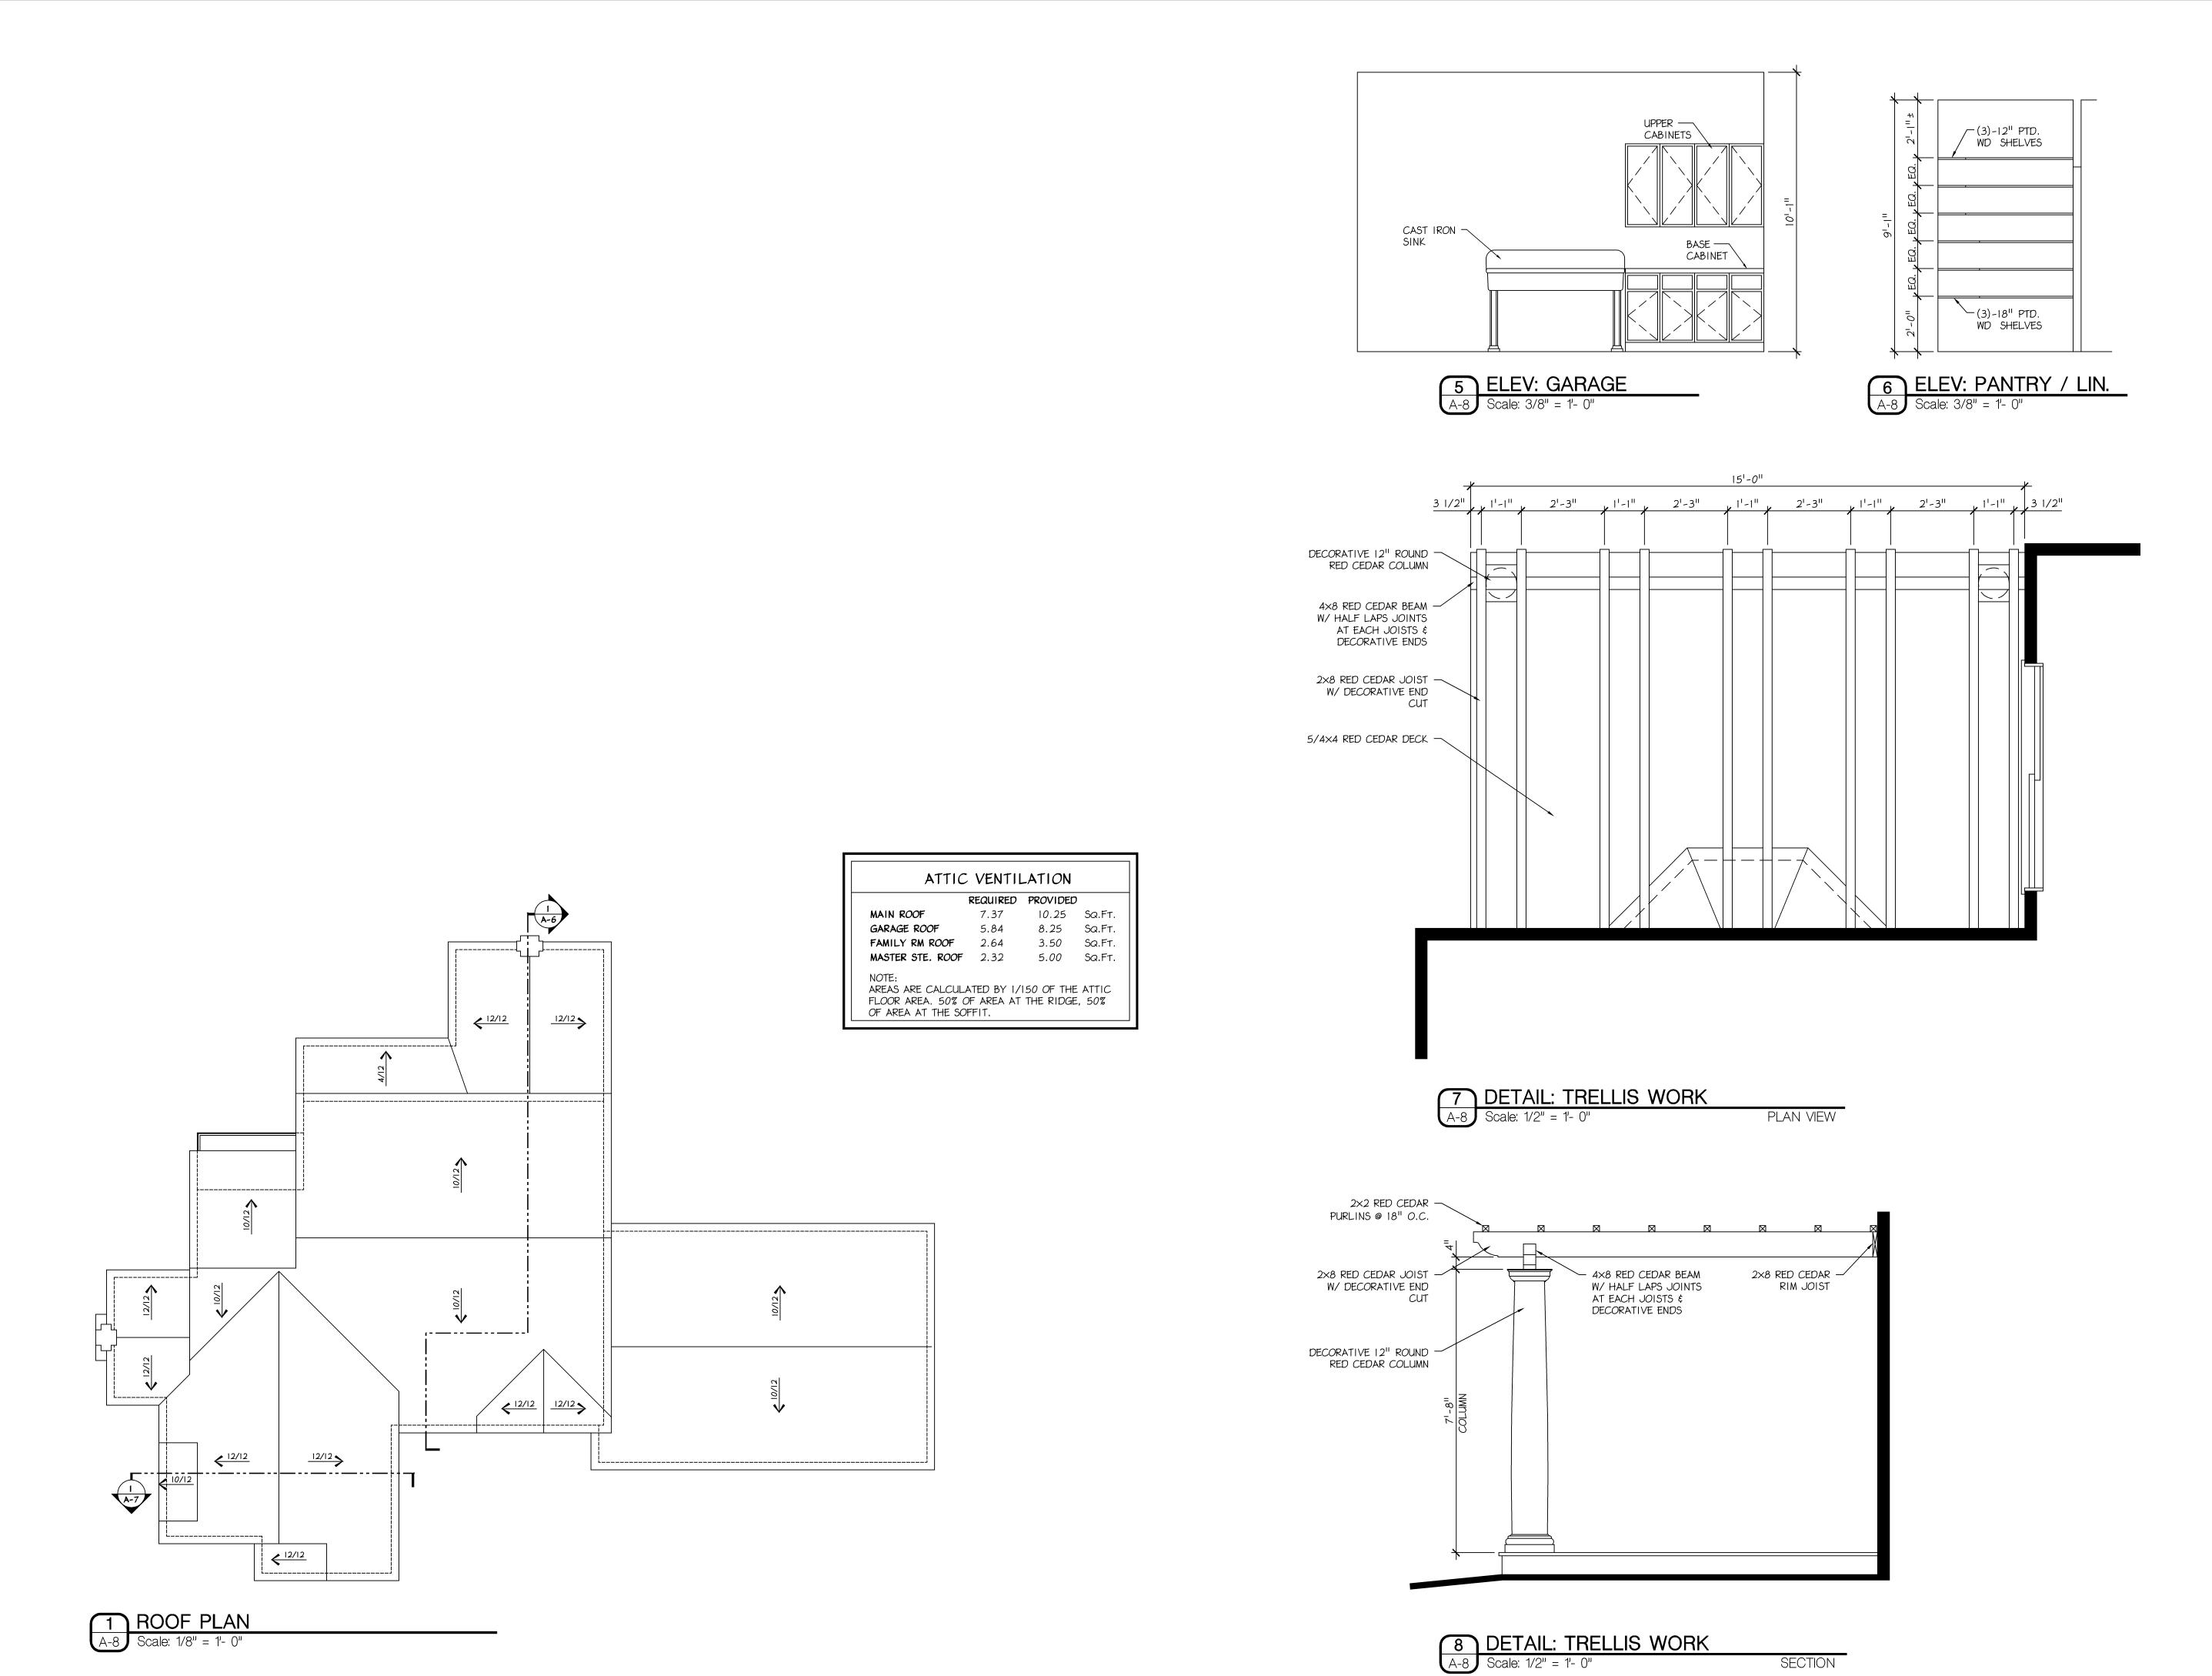

Robin J. Kohn, AIA

Regis W. Kubit, PE

S23 Kimberton Road, Suite 11B Phoenixville, PA 19460 tel. (610) 917-8831 fax (610) 917-8836 email mail@betzwood.com

Robin J. Kohn, AIA Commonwealth of Pennsylvania License No. RA-11327-X

> Contact Person: Edward M. Happ (610) 917-8831

PROJECT NO. DRAWN BY CHK'D BY B 2126 NO. DATE BY ISSUE ISSUED FOR CLIENT REVIEW 06-04-04 ISSUED FOR CLIENT REVIEW 06-24-04 ISSUED FOR PRE-BID 07-23-04 08-16-04 ISSUED FOR CONSTRUCTION 10-01-04 EMH APPROVED BY CURRENT DATE Robin J. Kohn, AIA December 07, 2004

Camp Residence

LOT #5 DICKSON DRIVE MALVERN, PA 19355

CHARLESTOWN TWP.
CHESTER COUNTY

SHEET TITLE

ROOF PLAN & DETAILS

SHEET NUMBER

A-8

REV 7

THE PROJECT CONSISTS OF CONSTRUCTION OF A TWO STORY HOME, ATTACHED GARAGE AND SITE WORK INCLUDING DRIVES, WALKS, MASONRY WALLS AND PAVING. THE FIRST STORY IS APPROXIMATELY 2278 SQ.FT. OF CONDITIONED AREA AND THE SECOND STORY CONTAINS 1438 SQ.FT. WITH A 805 SQ.FT. 2-CAR GARAGE AREA. THE TOTAL FRAMED AREA FOR THE HOME

1. PROJECT LOCATION: LOT #5, CHARLESTOWN TOWNSHIP, CHESTER COUNTY, PENNSYLVANIA

CONTRACTOR USE OF PREMISES

2. OWNER: BARBARA & ROBERT CAMP

GENERAL: DURING THE CONSTRUCTION PERIOD THE CONTRACTOR SHALL HAVE FULL USE OF THE PREMISES FOR CONSTRUCTION OPERATIONS. INCLUDING USE OF THE SITE. THE CONTRACTOR'S USE OF THE PREMISES IS LIMITED ONLY BY THE OWNER'S RIGHT TO PERFORM WORK OR TO RETAIN OTHER CONTRACTORS ON PORTIONS OF THE PROJECT.

THIS SECTION INCLUDES ADMINISTRATIVE AND PROCEDURAL REQUIREMENTS GOVERNING ALLOWANCES.

SELECTED MATERIALS AND EQUIPMENT ARE SPECIFIED IN THE CONTRACT DOCUMENTS BY ALLOWANCES. IN SOME CASES, THESE ALLOWANCES INCLUDE INSTALLATION. ALLOWANCES HAVE BEEN ESTABLISHED IN LIEU OF ADDITIONAL REQUIREMENTS AND TO DEFER SELECTION OF ACTUAL MATERIALS AND EQUIPMENT TO A LATER DATE WHEN ADDITIONAL INFORMATION IS AVAILABLE FOR EVALUATION. IF NECESSARY, ADDITIONAL REQUIREMENTS WILL BE ISSUED BY CHANGE ORDER.

SELECTION AND PURCHASE

1. AT THE EARLIEST PRACTICAL DATE AFTER AWARD OF THE CONTRACT, ADVISE THE ARCHITECT OF THE DATE WHEN THE FINAL SELECTION AND PURCHASE OF EACH PRODUCT OR SYSTEM DESCRIBED BY AN ALLOWANCE MUST BE COMPLETED TO

2. AT THE ARCHITECT'S REQUEST, OBTAIN PROPOSALS FOR EACH ALLOWANCE FOR USE IN MAKING FINAL SELECTIONS. INCLUDE RECOMMENDATIONS THAT ARE RELEVANT TO PERFORMING THE WORK,

SCHEDULE OF ALLOWANCES

ALLOWANCES FOR THE FIXTURES/MATERIAL ONLY, CONTRACTOR TO PROVIDE INSTALLATION AND PLUMBING/POWER TO FIXTURE/MATERIAL.

PLUMBING FIXTURE: LUMP SUM \$15,000 ELECTRICAL FIXTURES: EA. TYPICAL \$100 EA. CHANDELIER \$1200 EA. OTHER \$150 DOORS: FRONT DOOR \$2500 EA. INTERIOR \$125 EA. EXTERIOR \$250 EA. GARAGE (2) \$3500 HARDWARE: EA. DOOR \$75 INTERIOR WOOD FLOORING: S.F. \$3.50 TILE S.F. \$3.00 FIREPLACE MATERIALS: EA. TYPICAL \$1200 INSPECTION & TESTING \$1500 WINDOWS TOTAL (77) \$50,000

APPLICATION FOR PAYMENT

APPLIANCES \$10,000

VENT HOOD \$1200

COORDINATE THE SCHEDULE OF VALUES AND APPLICATIONS FOR PAYMENT WITH THE CONTRACTOR'S CONSTRUCTION SCHEDULE, SUBMITTAL SCHEDULE AND LIST OF SUBCONTRACTORS.

SUBMIT THE SCHEDULE OF VALUES FOR THE PROJECT TO THE ARCHITECT AT THE EARLIEST POSSIBLE DATE BUT NO LATER THAN SEVEN (7) DAYS BEFORE THE DATE SCHEDULED FOR THE FIRST SUBMITTAL OF THE INITIAL APPLICATION FOR PAYMENT. ARRANGE THE SCHEDULE OF VALUES IN TABULAR FORM WITH SEPARATE COLUMNS TO INDICATE THE FOLLOWING FOR EACH

A. RELATED SPECIFICATION SECTION OR DIVISION B. DESCRIPTION OF WORK

NAME OF SUBCONTRACTOR . NAME OF MANUFACTURER OR FABRICATOR E. NAME OF SUPPLIER

PROVIDE A BREAKDOWN OF THE CONTRACT SUM IN SUFFICIENT DETAIL TO FACILITATE CONTINUED EVALUATION OF APPLICATIONS FOR PAYMENT AND PROGRESS REPORTS. BREAK PRINCIPAL SUBCONTRACT AMOUNTS DOWN INTO SEVERAL LINE

INDUSTRY STANDARDS

APPLICABILITY OF STANDARDS: EXCEPT WHERE THE CONTRACT DOCUMENTS INCLUDE MORE STRINGENT REQUIREMENTS. APPLICABLE CONSTRUCTION INDUSTRY STANDARDS HAVE THE SAME FORCE AND EFFECT AS IF BOUND OR COPIED DIRECTLY INTO THE CONTRACT DOCUMENTS TO THE EXTENT REFERENCED. SUCH STANDARDS ARE MADE PART OF THE CONTRACT DOCUMENTS BY REFERENCE.

DIVISION 2 - SITEWORK

PROTECT VEGETATION TO REMAIN; REMOVE STUMP TO 2 FEET BELOW FINISH GRADE. ACCESS: PROVIDE TEMPORARY ROAD ONSITE. DRAINAGE: TEMPORARY GRADING, DITCHING, PUMPING, CULVERT IF NEEDED. SURVEY: BY OWNER AS REQUIRED BY CONTRACTOR.

EARTHWORK (SELECT FILL FOR BUILDING, VEHICLE PAVING, MEP BACKFILL) SELECT FILL: 95% DENSITY; LIQUID 30-45; PLASTICITY 7-20; STONE MAX 3"; SAND ACCEPTABLE ONLY IF NO HEAD OF

WATER POSSIBLE. ORDINARY FILL: FREE OF ORGANIC TOPSOIL, TRASH, DEBRIS, LARGE STONE. TOPSOIL: REMOVE 6": SAVE FOR REUSE OR CONVERT TO SELECT FILL WITH LIME. NOTE: REFER TO STRUCTURAL SPECIFICATIONS FOR ADDITIONAL BUILDING PAD INFORMATION. FOLLOW THE MORE

STRINGENT SPECIFICATION IF THERE ARE CONFLICTS BETWEEN THIS SPECIFICATION AND STRUCTURAL.

EXCAVATION FOR BUILDING CONSTRAINT: ANGLE OF REPOSE 45° FOR SOIL; SHORE AND DEWATER.

FOOTINGS ADJUST CONTRACT IF FARTH UNSUITABLE REMOVE INFILL LIME STABILIZATION: PER STATE DEPARTMENT OF HIGHWAY AND PUBLIC TRANSPORTATION ITEM 264.

LANDSCAPE GRADING (MIN 1/8" PER FOOT SLOPE) SPRINKLE TO COMPACT 3" TOPSOIL SMOOTH; STONE MAX I"; ALLOW I"

FLEXIBLE BASE CRUSHED LIMESTONE. SUBGRADE COMPACTION 95% AT OPTIMUM MOISTURE, 6" DEPTH.

SLOPE (SURFACE, BASE AND SUB-BASE); MINIMUM 1/16" PER FOOT.

PAVING ASPHALT (MINIMUM 1/16" PER FOOT SLOPE)

TERMITE TREATMENT WARRANTY: 5 YEARS,; REPLACE TERMITE DAMAGE TO BUILDING AND CONTENTS. APPLICATOR: BONDED; LICENSED.

DIVISION 3 - CONCRETE

CAST-IN-PLACE CONCRETE

ALL REINFORCED CONCRETE SHALL BE FURNISHED AND INSTALLED IN ACCORDANCE WITH THE CURRENT ACI-318 "BUILDING CODE REQUIREMENTS FOR REINFORCED CONCRETE.

CONCRETE SHALL HAVE A MINIMUM 28 DAY COMPRESSIVE STRENGTH OF 3,500 PSI.

CEMENT SHALL BE PORTLAND CEMENT CONFORMING TO ASTM C150 - TYPE 11.

REINFORCING STEEL SHALL CONFORM TO ASTM-A615 GRADE 60. WELDED WIRE FABRIC SHALL BE 6×6, #10/10 AND CONFORM

IN ON-GRADE CONCRETE SLABS THE W.W.F. REINFORCEMENT SHALL BE LOCATED MIDWAY IN THE SLAB THICKNESS.

ALL EXTERIOR CONCRETE TO BE AIR-ENTRAINED. PROVIDE 5% ± 1% AIR ENTRAINMENT. AIR ENTRAINMENT TO BE IN ACCORDANCE WITH ACI 301. NO OTHER ADMIXTURE SHALL BE USED UNLESS APPROVED BY THE ENGINEER.

PROVIDE CONCRETE REINFORCING BARS AT FOOTING LOCATIONS WHERE SOIL IS ENGINEERED FILL. BARS SHALL BE (3)#4, AT THE BOTTOM WITH A MINIMUM OF 2^{II} CONCRETE COVER, UNLESS NOTED OTHERWISE. CONCRETE REINFORCING BARS ARE NOT REQUIRED AT FOOTINGS BEARING ON UNDISTURBED SOIL WITH A BEARING CAPACITY OF 2,000 PSF UNLESS NOTED

THE TOP OF ALL CONCRETE SURFACES SHALL BE TRUE LEVEL WITH A SMOOTH FLOAT FINSH, UNLESS OTHERWISE NOTED. EXTERIOR WALKING SURFACES SHALL RECEIVE A BROOM FINISH. ALL DIMENSIONS SHALL BE WITHIN ± 1/8 INCH.

PROVISIONS MUST BE TAKEN TO PROTECT ALL CONCRETE WORK FROM FROST DAMAGE WITH SPECIAL ATTENTION PAID TO FOOTINGS AND OTHER ON-GRADE CONSTRUCTION PRIOR TO BACKFILLING AND ENCLOSING THE BUILDING.

ANCHOR BOLTS SHALL BE GALVANIZED 5/8" DIAMETER (MIN.) - 12" IMBEDDED FOR CONCRETE WALLS - 18" IMBEDDED FOR CMU WALLS. PLACEMENT OF ANCHOR BOLTS SHALL BE 6^{1} - 0^{11} O.C. (MAX.) INTERMEDIATE SPACING, MINIMUM 2 BOLTS PER PLATE SECTION 12" (MIN.) FROM PLATE END. APPROVED GALVANIZED STRAP ANCHORS MAY BE SUBSTITUTED FOR ANCHOR BOLT METHOD.

PROVIDE 6 MIL POLYETHYLENE VAPOR BARRIER MEMBRANE COMPLYING WITH ASTM D-2103 UNDER SLABS WHERE INDICATED

ALL REINFORCEMENT, EMBEDDED STEEL, INSERTS AND ALL OTHER EMBEDDED ITEMS SHALL BE IN PLACE BEFORE THE START OF CONCRETE PLACEMENT.

DIVISION 4 - UNIT MASONRY

ACCESSORY AND MORTAR MORTAR TYPE S LIME; ADMIX OM BY OMICON OR HYDROCIDE BY SONNEBORN; COLOR INORGANIC (IF ANY) FIRE BRICK

MIX TYPE S HI STRENGTH. NO CHLORIDE. REINFORCE 9 GAUGE DEFORMED GALVANIZED; SMOOTH CROSSWIRE; AT MAX 24"; WIDTH 2" LESS THAN NOMINAL WALL. TIE CORNER AND VENEER 24 GAUGE \times 7/8" CORRUGATED 3" INTO MASONRY AT 24" \times 16" OR 15". FLEXIBLE ANCHOR MIN 3"X3"X3/16" DIAM. AT 16" (OR DOVETAIL BY HECKMAN)

NON-BEARING VENEER WALLS SHALL BE SET IN PORTLAND CEMENT MORTARTYPE SW COMPRESSIVE STRENGTH (FIM) 3,000 PSI. INSTALL GALVANIZED METAL MASONRY WALL TIES WITH 16" O.C. VERTICAL AND 32" O.C. HORIZONTAL SPACING STAGGERED. INSTALL FLASHING AT ALL LINTELS AND HEADERS AS NOTED IN DIVISION 7 AND/OR ON DRAWINGS. COLOR SELECTION BY ARCHITECT AND/OR OWNER MORTOR & GROUT SHALL MEET REQUIREMENTS OF ASTM C270 AND REQUIREMENTS SPECIFIED HEREIN. TYPE M MORTAR SHALL

BE USED FOR EXTERIOR WALLS BELOW GRADE; TYPE S MORTAR SHALL BE USED FOR WALLS AND PARTITIONS ABOVE GRADE.

BRICKWORK (FIREPLACE)

PROVIDE SAMPLES FIREBRICK GRADE MW: TYPE FBS: MODULAR, FIREBRICK AND FIREPROOF MORTAR.

LAY DAMP SAW EXPOSED CUT; MITER CORNER; FILL BED AND VERTICAL JOINT RELAY WITH FRESH MORTAR; AT BASE OR CLEAN: PROTECT ADJACENT: PROTECT EDGE AND CORNER

TOOL 3/8" CONCAVE JOINT IN RUNNING BOND (1/3 FOR KING-SIZE)

DIVISION 5 - METALS

SHEET METAL FABRICATIONS - REFERENCE HVAC DUCT WORK

DIVISION 6 - WOOD AND PLASTICS

ROUGH CARPENTRY

I. ALL LUMBER EXCEPT AS NOTED SHALL BE STRESS GRADED MINIMUM NO.2 MEDIUM GRADE KILN DRIED HEM/FIR (SEE STRUCTURAL FOR ADDITIONAL INFORMATION).

2. ALL PLYWOOD ROOF DECKING SHALL BE A MINIMUM 5/8" THICK C-C EXTERIOR = DFPA GRADE THAT COMPLIES WITH APA PERFORMANCE RATED SHEATHING (40/20 EXPOSURE) WITH 6D NAILS AT 6" ON EDGE AND 12" ON IMMEDIATE FRAMING UNLESS NOTED OTHERWISE ON DRAWINGS. STAGGER PLYWOOD JOINTS.

3. FOR PLYWOOD ROOF DECK SPANNING 19.2" OR GREATER, INSTALL SIMPSON OR EQUAL, PLYCLIPS ON HORIZONTAL JOINT AT MID-SPAN BETWEEN EACH ROOF RAFTER

4. ALL PLYWOOD FLOOR DECKING SHALL BE MINIMUM A-D EXTERIOR - DFPA GRADE WITH NAILS AT 6" ON EDGE AND 10" ON INTERMEDIATE FRAMING UNLESS NOTED OTHERWISE ON DRAWINGS.

5. PROVIDE TREATED WOOD FOR ANY FRAMING EXPOSED TO WEATHER OR MOISTURE CONDITIONS.

6. BRIDGING, FIRE STOPS AND BLOCKING TO COMPLY WITH GOVERNING BUILDING CODE.

7. AT ALL EXTERIOR WALLS, UPLIFT TIE DOWN SHEET METAL ANCHORS SHALL BE SPACED AT A MAXIMUM OF 32 INCHES ON CENTER. ANCHORS SHALL BE USED AT:

A. GROUND LEVEL SILL PLATE TO WALL STUD. B. WALL STUD TO WALL STUD CONNECTION PAST FLOOR CAP AND FLOOR PLATES C. WALL STUD TO ROOF TRUSSES

8. LUMBER SHALL BEAR AN APPROPRIATE INSPECTION BUREAU GRADE MARK. PLYWOOD SHALL BEAR AMERICAN PLYWOOD ASSOCIATION GRADE MARK.

9. DELIVERY AND STORAGE: KEEP MATERIALS UNDER COVER AND DRY. PROTECT AGAINST EXPOSURE TO WEATHER AND CONTACT WITH DAMP OR WET SURFACES, STACK LUMBER AS WELL AS PLYWOOD AND OTHER PANELS; PROVIDE FOR AIR CIRCULATION WITHIN AND AROUND STACKS AND UNDER TEMPORARY COVERINGS INCLUDING POLYETHYLENE AND SIMILAR MATERIAL. FOR LUMBER AND PLYWOOD PRESSURE TREATED WITH WATER-BORNE CHEMICALS, STICKER BETWEEN EACH COURSE TO PROVIDE AIR CIRCULATION.

10. COORDINATION: FIT CARPENTRY WORK TO OTHER WORK; SCRIBE AND COPE AS REQUIRED FOR ACCURATE FIT. CORRELATE LOCATION OF FURRING, NAILERS, BLOCKING, GROUNDS AND SIMILAR SUPPORTS TO ALLOW ATTACHMENT OF OTHER WORK INCLUDING WINDOW TREATMENT, FINISH CARPENTRY, ARCHITECTURAL WOODWORK, COORDINATE LOCATIONS

WITH INTERIOR DESIGN DRAWINGS. II. LUMBER STANDARDS: MANUFACTURER LUMBER TO COMPLY WITH PS 20 "AMERICAN SOFTWOOD LUMBER STANDARD" AND

WITH APPLICABLE GRADING RULES OF INSPECTION AGENCIES CERTIFIED BY AMERICAN LUMBER STANDARDS COMMITTEE'S

12. PROVIDE DRESSED LUMBER, S4S, UNLESS OTHERWISE INDICATED.

13. PROVIDE SEASONED LUMBER WITH 19% MAXIMUM MOISTURE CONTENT AT TIME OF DRESSING AND SHIPMENT FOR SIZES 211 OR LESS IN NOMINAL THICKNESS, UNLESS OTHERWISE INDICATED.

14. FOR FRAMING PROVIDE THE FOLLOWING GRADE AND SPECIES:

I. STRUCTURAL BEAMS AND COLUMNS SHALL BE WPA SELECT STRUCTURAL NO.1 GRADE, HEM/FIR. HAVING A FB=975 PSI FLOOR, CEILING JOIST AND RAFTERS SHALL BE WPA NO. 2 GRADE, HEM/FIR, HAVING A FB=850 PSI III. WALL STUDS SHALL BE WPA NO.2 GRADE, HEM/FIR. HAVING A FB=675 PSI

14. PROVIDE WOOD FOR SUPPORT OR ATTACHMENT OF OTHER WORK INCLUDING BUCKS, NAILERS, BLOCKING, FURRING. GROUNDS, STRIPPING AND SIMILAR MEMBERS. PROVIDE LUMBER OF SIZES INDICATED, WORKED INTO SHAPES SHOWN.

15. PROVIDE BACKING PANELS: FOR MOUNTING ELECTRICAL OR TELEPHONE EQUIPMENT, PROVIDE FIRE RETARDANT TREATED PLYWOOD PANELS WITH GRADE DESIGNATION, APA C-D PLUGGED INT WITH EXTERIOR GLUE, IN THICKNESS NOT LESS THAN

16. MISCELLANEOUS MATERIALS:

(ALSC) BOARD OF REVIEW.

A. FASTENERS AND ANCHORAGES: PROVIDE SIZE, TYPE MATERIAL AND FINISH AS INDICATED AND AS RECOMMENDED BY APPLICABLE STANDARDS, COMPLYING WITH APPLICABLE FEDERAL SPECIFICATIONS FOR NAILS, STAPLES, SCREWS, BOLTS, NUTS, WASHERS AND ANCHORING DEVICES. PROVIDE METAL HANGERS AND FRAMING ANCHORS OF THE SIZE AND TYPE RECOMMENDED BY THE MANUFACTURER FOR EACH USE INCLUDING RECOMMENDED NAILS. B. WHERE ROUGH CARPENTRY WORK IS EXPOSED TO WEATHER, IN GROUND CONTACT, OR IN AN AREA OF HIGH RELATIVE HUMIDITY, PROVIDE FASTENERS AND ANCHORAGES WITH A HOT-DIP ZINC COATING (ASTMA 153).

17. WOOD TREATMENT BY PRESSURE PROCESS:

A. PRESERVATIVE TREATMENT: WHERE LUMBER OR PLYWOOD IS INDICATED AS "TRT-WD" OR "TREATED", OR IS SPECIFIED HEREIN TO BE TREATED, COMPLY WITH APPLICABLE REQUIREMENTS OF AWPA STANDARDS C2 (LUMBER) AND C9 (PLYWOOD) AND OF AWPB STANDARDS LISTED BELOW. MARK EACH TREATED ITEM WITH THE AWPB QUALITY MARK REQUIREMENTS.

I. PRESSURE-TREAT ABOVE-GROUND ITEMS WITH WATER-BORNE PRESERVATIVES TO COMPLY WITH AWPB LP-2. AFTER TREATMENT, KILN-DRY LUMBER AND PLYWOOD TO A MAXIMUM MOISTURE CONTENT, RESPECTIVELY, OF 19% AND 15%. TREAT 1. NAILERS, CURBS, BLOCKING, STRIPPING AND SIMILAR MEMBERS IN CONNECTION WITH FLASHING, AND AT WINDOWS

II. COMPLETE FABRICATION OF TREATED ITEMS PRIOR TO TREATMENT, WHERE POSSIBLE. IF CUT AFTER TREATMENT, COAT CUT SURFACES WITH HEAVY BRUSH COAT OF SAME CHEMICAL USED FOR TREATMENT AND TO COMPLY WITH AWPA M4. INSPECT EACH PIECE OF LUMBER OR PLYWOOD AFTER DRYING AND DISCARD DAMAGED OR DEFECTIVE PIECES.

INSTALLATION, GENERAL:

PRE-DRILL AS REQUIRED.

A. DISCARD UNITS OF MATERIAL WITH DEFECTS WHICH MIGHT IMPAIR QUALITY OF WORK AND UNITS WHICH ARE TOO SMALL TO USE IN FABRICATING WORK WITH MINIMUM JOINTS OR OPTIMUM JOINT ARRANGEMENT.

B. SET CARPENTRY WORK TO REQUIRED LEVELS AND LINES, WITH MEMBERS PLUMB AND TRUE AND ACCURATELY CUT AND

C. SECURELY ATTACH CARPENTRY WORK TO SUBSTRATE BY ANCHORING AND FASTENING AS SHOWN AND AS REQUIRED BY RECOGNIZED STANDARDS. COUNTERSINK NAIL HEADS ON EXPOSED CARPENTRY WORK AND FILL HOLES.

D. USE COMMON WIRE NAILS, EXCEPT AS OTHERWISE INDICATED. USE FINISHING NAILS FOR FINISH WORK. SELECT FASTENERS OF SIZE THAT WILL NOT PENETRATE MEMBERS WHERE OPPOSITE SIDE WILL BE EXPOSED TO VIEW OR WILL RECEIVE FINISH MATERIALS. MAKE TIGHT CONNECTIONS BETWEEN MEMBERS. INSTALL FASTENERS WITHOUT SPLITTING OF WOOD;

WOOD GROUNDS, NAILERS, BLOCKING AND SLEEPERS:

A. PROVIDE WHEREVER SHOWN AND WHERE REQUIRED FOR SCREEDING OR ATTACHMENT OF OTHER WORK, FORM TO SHAPES AS SHOWN AND CUT AS REQUIRED FOR TRUE LINE AND LEVEL OF WORK TO BE ATTACHED. COORDINATE LOCATION WITH OTHER WORK INVOLVED B. ATTACH TO SUBSTRATES AS REQUIRED TO SUPPORT APPLIED LOADING. COUNTERSINK BOLTS AND NUTS FLUSH WITH SURFACES, UNLESS OTHERWISE INDICATED.

INSTALL PLUMB AND LEVEL WITH CLOSURE STRIPS AT EDGES AND OPENINGS. SHIM WITH WOOD AS REQUIRED FOR TOLERANCE OF FINISHED WORK

PREFABRICATED TRUSSES

PREFABRICATED TIMBER TRUSSES SHALL BE DESIGNED FOR LOADS ON A HORIZONTAL PROJECTION AS FOLLOWS: AVIN SNOW LOAD PER TOWNSHIP CODE TOP CHORD LIVE LOAD PER TOWNSHIP CODE TOP CHORD DEAD LOAD PER TOWNSHIP CODE

BOTTOM CHORD DEAD LOAD 15 PSF BOTTOM CHORD LIVE LOAD 15 PSF TOTAL LOAD DEFLECTION NOT TO EXCEED 1/240 OF THE SPAN

TOP CHORD WIND LOAD

WINDWARD SIDE -25 PSF (FOR UPWARD LOAD, DESIGN SHALL CONSIDER WIND LOAD IN CONJUNCTION WITH 90% OF DEAD LOADS AS STATED ABOVE) LEEWARD SITE -25 PSF (FOR UPWARD LOAD, DESIGN SHALL CONSIDER WIND LOAD IN CONJUNCTION WITH 90% OF DEAD LOAD AS STATED ABOVE).

TRUSSES SHALL BE DESIGNED IN ACCORDANCE WITH THE LOCAL GOVERNING BUILDING CODE. TRUSS MEMBERS SHOWN ON DETAILS ARE MINIMUM SIZE AND NUMBER TO BE USED. TRUSS LAYOUT AS SHOWN ON DRAWINGS IS NOT TO BE DEVIATED FROM UNLESS APPROVED BY THE STRUCTURAL ENGINEER. ALL LUMBER SHALL BE STRESS GRADED LUMBER #2 S.T.F.I.D. MINIMUM. ALL METAL CONNECTION PRESS PLATES SHALL BE SIZED FOR 125% OF MEMBER FORCES WITH NO INCREASE IN PLATE VALUES OR DECREASES OF MEMBER LOADS FOR DURATION OF LOADING OR OTHER FACTORS. MINIMUM SIZE OF PLATES SHALL BE 15 SQ. IN., HAVING A MINIMUM BITE OF 2 1/2 INCHES ON ANY MEMBER MEASURED ALONG THE CENTERLINE OF WEBS AND PERPENDICULAR TO CHORD AXES. NO PANEL POINT SHALL HAVE MORE THAN ONE PLATE PER TRUSS SIDE. TRUSS MANUFACTURER SHALL SUBMIT FOR REVIEW, TRUSS FABRICATION AND ERECTION DRAWINGS, TRUSS DESIGN DATA AND DESIGN CALCULATIONS - ALL TO BE SEALED BY A REGISTERED STRUCTURAL ENGINEER LICENSED IN THE STATE OF PENNSYLVANIA. THE TRUSS DESIGN DATA SHALL INCLUDE LUMBER SPECIES, GRADE AND SIZE OF EACH MEMBER, DESIGN LOADING AND DESIGN OF ALL CONNECTIONS. THE TRUSS MANUFACTURER SHALL DESIGN AND INCLUDE ALL TRUSS ACCESSORIES, AND DESIGN AND SHOW PERMANENT AND TEMPORARY BRIDGING AND BRACING, TO BE INSTALLED BY THE ERECTOR, ON THE ERECTION DRAWINGS.

ROOF TRUSS: MINIMUM TOP AND BOTTOM CHORD MEMBER IS 2X6. MAXIMUM CLEAR SPAN, TOP CHORD: II'-0" FOR 2X6: 14'-0" FOR 2x4. MAXIMUM CLEAR SPAN BOTTOM CHORD 13'-0" FOR 2x6.

STRUCTURAL GLUED LAMINATED TIMBER

1. PRODUCT DATA INCLUDING SPECIFICATIONS AND INSTALLATION INSTRUCTIONS COVERING LUMBER, ADHESIVES, FABRICATION PROCESS. PRESERVATIVE TREATMENT, ACCESSORIES AND PROTECTION

2. SHOP DRAWINGS SHOWING FULL DIMENSIONS FOR EACH MEMBER AND LAYOUT OF ENTIRE STRUCTURAL SYSTEM. SHOW LARGE-SCALE DETAILS OF CONNECTIONS, CONNECTORS AND OTHER ACCESSORIES. INDICATE SPECIES AND LAMINATING COMBINATION, ADHESIVE TYPE AND OTHER VARIABLES IN REQUIRED WORK

1. SHOW LOADING SECTION SIZES, ASSUMED DESIGN VALUES, STRESS DIAGRAMS AND CALCULATIONS AND SIMILAR INFORMATION NEEDED FOR ANALYSIS.

3. STANDARDS: COMPLY WITH ANSI/AITC A 190.1 "STRUCTURAL GLUED LAMINATED TIMBER".

4. MANUFACTURER QUALIFICATION: PROVIDE FACTORY-GLUED STRUCTURAL UNITS, PRODUCED BY AN AITC-LICENSED FIRM QUALIFIED TO APPLY THE AITC QUALITY INSPECTION MARK.

5. FACTORY-MARK EACH PIECE OF GLUED LAMINATED STRUCTURAL UNITS WITH AITC QUALITY INSPECTED MARK.

6. ENGINEER QUALIFICATIONS: A PROFESSIONAL ENGINEER WHO IS LEGALLY AUTHORIZED TO PRACTICE IN JURISDICTION WHERE PROJECT IS LOCATED AND EXPERIENCED IN PROVIDING ENGINEERING SERVICES TOWARD THE INSTALLATION AND SUCCESSFUL IN-SERVICE PERFORMANCE OF GLULAM UNITS SIMILAR TO THE PROJECT IN MATERIAL, DESIGN AND EXTENT.

7. FINISH: FINISH FABRICATED ASSEMBLIES WITH RUST-INHIBITIVE PRIMER.

8. WET-USE FINISH: WHERE WET-USE GLULAM WORK IS INDICATED, FINISH FABRICATED ASSEMBLIES WITH HOT-DIP ZINC COATING (ASTM A 153), INCLUDING BOLTS AND OTHER FASTENERS.

9. END-CUT SEALING: IMMEDIATELY, AFTER END-CUTTING EACH MEMBER TO FINAL LENGTH, AND AFTER WOOD TREATMENT (IF ANY), APPLY A SATURATION COAT OF END SEALER TO ENDS AND OTHER CROSS-CUT SURFACE, KEEPING SURFACES FLOOD-COATED FOR NOT LESS THAN 10 MINUTES.

10. SEAL COAT: AFTER FABRICATING AND SANDING EACH UNIT, AND END-COAT SEALING, APPLY A HEAVY SATURATION COAT OF PENETRATING SEALER ON SURFACES OF EACH UNIT, EXCEPT FOR TREATED WOOD WHERE TREATMENT HAS INCLUDED A WATER REPELLENT

INSTALLATION 1. GENERAL: INSTALL MISCELLANEOUS STEEL CONNECTORS, ANCHORS AND ACCESSORIES.

2. PLAN AND EXECUTE ERECTION PROCEDURES SO THAT CLOSE FIT AND NEAT APPEARANCE OF JOINTS AND STRUCTURE AS A WHOLE WILL NOT BE IMPAIRED. WHEN HOISTING MEMBERS INTO PLACE, USE PADDED OR NON-MARRING SLINGS, AND PROTECT CORNERS WITH WOOD BLOCKING.

3. ADEQUATELY BRACE MEMBERS AS THEY ARE PLACED TO MAINTAIN SAFE POSITION UNTIL FULL STABILITY IS PROVIDED.

FINISH CARPENTRY ARCHITECTURAL WOODWORK (FABRICATED WOOD PRODUCT, HARDWOOD)

STANDARD: ARCHITECTURAL GRADE QUALITY STANDARDS OF THE ARCHITECT WOODWORK INDUSTRY BY AWII SUBMIT SHOP DRAWINGS; SAMPLE PLASTIC LAMINATE, NATURAL FINISH SPECIES. TRIM: STANDARD: MAX 9 FT. EASE EXPOSED EDGE. SOLID STOCK: MOISTURE 8-13% OVEN DRY WEIGHT; CLOSE GRAIN FOR PAINT GRADE.

PLASTIC LAMINATE: 1/16" W/BALANCE SHEET; CORE 3/4" B PLYWOOD. EXECUTION: TO ACCURATE FORCE FIT; SCARF JOINT; COPE/MITER CORNER, SCRIBE. NAILING: CONCEAL: SET FOR PUTTY; AT 12-24"; DOUBLE IF WIDTH OVER 4"; HOT-DIP GALVANIZE, CADMIUM OR ALUMINUM FOR EXTERIOR, EXCEPT STAINLESS STEEL FOR EXTERIOR NATURAL.

CABINET: 3/4" THICK EXCEPT 1/2" DRAWER SIDE, BACK; 1/4" DRAWER BOTTOM, CABINET BACK; SHELF 7/8" FOR 3 1/2 FT. OR 1-1/16" TO 4 FT. DOOR LAYOVER. BASE 4" HI BY 3" TOE SPACE AND 1/2" RECESS AT CABINET END. HARDWARE TO BE SELECTED BY OWNER.

INTERIOR ARCHITECTURAL WOODWORK:

FOLLOW AWI ARCHITECTURAL GRADE QUALITY STANDARDS

DIVISION 7 - THERMAL AND MOISTURE PROTECTION ROOFING & UNDERLAYMENT

SHINGLES SHALL BE ASPHALT AND FIBERGLASS COMPOSITE DESIGNER SERIES, CONFORMING TO U.L. CLASS "A" FIRE RESISTANCE, ASTM D3462 AND ASTM D3018 TYPE I WITH A 30 YEAR (MIN.) LIMITED MANUF, WARRANTY. SHINGLES SHALL BE INSTALLED AS PER MANUFACTURER'S INSTRUCTIONS. SHINGLES SHALL BE STYLE "GRAND MANOR" MANUFACTURED BY CERTAINTEED CORPORATION OR APPROVED EQUAL (APPROVED BY OWNER \$ ARCHITECT). COLOR SELECTION BY OWNER.

PROVIDE AND INSTALL ONE LAYER NO. 30 ASPHALT SATURATED UNPERFORATED ORGANIC FELT COMPLYING WITH ASTM D226 TYPE 1, 36" WIDE, APPROXIMATE WEIGHT 36 LBS. PER SQUARE; UNDER ROOF SHINGLES, LAPPING SUCCEEDING COURSES 2" (MIN.). IN ADDITION TO FELT UNDERLAYMENT PROVIDE A CONTINUOUS STRIP OF ICE PROTECTION UNDERLAYMENT OF NO. 90 ASPHALT ROLL ROOFING ALONG THE EAVES TO A POINT 12" (MIN.) BEYOND WALL LINE. PROVIDE NO. 90 ASPHALT ROLL ROOFING AT THE VALLEYS. AT ALTERNATE LACE VALLEYS PROVIDE TWO (2) LAYERS NO. 15 ORGANIC FELT UNDER SHINGLES OR ONE (1) LAYER NO. 30 ORGANIC FELT. ALTERNATE FOR ICE PROTECTION IS 40 MIL SELF ADHERED ICE & WATER SHIELD

SIDING & TRIM JAMES HARDI CEMENT FIBER BUILDING PRODUCTS. FOLLOW MANUFACTURER RECOMMENDATIONS FOR INSTALLATION AND

FYPON MOLDING MILLWORK. FOLLOW MANUFACTURER RECOMMENDATIONS FOR INSTALLATION AND FINISH.

INSTALLATION, BATT AND BLANKET FIBER, COVER: MINERAL WOOL OR GLASS FIBER; I KRAFT FACE IF SHOWN; UL LABEL THERMAL RESISTANCE: EXTERIOR WALLS: R21 (5 1/2") BASEMENT OR CRAWL SPACES: R30 (8 1/4")

2ND FLR.CEILING: R38 (10 1/4") INTERIOR WALLS: RII (3 1/2") ONLY AS REQUIRED OR NOTED. NOTED LOCATIONS: ALL BEDROOMS, ALL BATHROOMS & LAUNDRY ROOM. INSTALLATION: FIT SNUG; PERMANENTLY RETAIN BY GALVANIZED WIRE IF OPEN FACE.

JOINT SEALING (MAX. 1/2" THICK) SUPPLIER: DAP. DOW CORNING, GE

INSPECTION: DO NOT COVER UNTIL APPROVED.

EXPOSED: ACRYLIC, BUTYL, POLYSULFIDE, SILICONE OR URETHANE. OIL, LINSEED, ASPHALTIC AND COAL TAR BASE TYPE UNACCEPTABLE. FILLER PLASTIC OR RUBBER. CONSEALED: LINSEED OIL OR OTHER OIL BASE NONSKINNING; OR EXPOSED TYPE. APPLICATION: TOOL JOINT CONCAVE. PROMPTLY REMOVE OVERRUN WITH SOLVENT.

ROOF METAL (ROOF FLASHING) STANDARD: SMACNA MANUAL WARRANT FOR 2 YEARS AGAINST LEAK, WRINKLE AND DETERIORATION. GALVANIZE: HOT-DIP MIN 1.25 OZ. ZINC PSF; PAINTGRIP BY ARMCO OR EQUAL.

FINISH: STAIN GRADE WOOD; NATURAL FINISH SPECIES FILL OPEN GRAIN.

DIVISION 8 - DOORS AND WINDOWS

DOOR WOOD FLUSH (INSTALLED BY FINISH CARPENTRY) STANDARD: NWMA RESIDENTIAL SOLID CORE: WOOD PLAIN OR FRAME: PARTICLE BOARD DENSITY C; MINERAL (FIRE)

ITEM: GUTTER & PETER PIPE, VALLEY, RAKE, DRIP, GABLE OR RIDGE VENT, FILLER.

GLAZING (GOVERN GLASS)

SECTIONAL OVERHEAD AND COILING

ALLOWANCE PER OWNER SELECTION.

STANDARD: MIRROR Q2 PLATE OR FLOAT Q3 PER FS DD G451D; WIND PER ANSI 58.1. WOOD MIRROR (UNFRAMED PLATE): ELECTROPLATE COPPER WARRANTED 5 YEARS; EASE, POLISH, SEAL 100%; MASTIC 35%; BLOCK AT 1/4 PT: CLAMP KV 227 BOT. 278 TOP. SAFETY: TEMPERED OR LAMINATED; PER CODE AND GOVERNING AUTHORITY.

HARDWARE, WEATHERSTRIP (EXCEPT FOR CABINET, SPECIAL OPENING, WINDOW) SUBMIT: SCHEDULE, BROCHURE, TEMPLATE TO DOOR, SAMPLE LABEL PER DRAWING. ALLOWANCE: PURCHASE AND DELIVER READY TO INSTALL KEY, PACK MARK: EACH ITEM SEPARATE; KEY AS DIRECTED.

DIVISION 9 - FINISHES

FLOORING: ALLOWANCE

SUBFLOOR: 3/4" TEG PLYWOOD

GYPSUM DRYWALL (OR WOOD FRAMING)

STANDARD: RECOMMENDED SPECIFICATIONS BY GYPSUM ASSOCIATION. MATERIAL: AS SHOWN BY USG OR EQUAL; TRIP GALV. OUTSIDE CORNER AND TO BUTT OTHER MATERIAL; FLOAT FLANGE UNLESS EXPOSED TYPE SHOWN.

ATTACH: JOINT AT SUPPORT; CEILING BOARD ACROSS JOIST. PLANE, PARALLEL AND AT 90°. NAIL AT 12", DOUBLE IN FIELD; VERTICAL EDGE AT 8".

FINISH SMOOTH TO JOINT INVISIBLE WHEN PAINTED; TAPE AND FILL ABOVE CEILING. FLOORING WOOD STANDARD: NATURAL OAK FLOORING MANUFACTURER'S ASSOCIATION

INSTALLATION: BLIND NAIL AT 12"; SAND LEVEL; FINISH SPECIFIED BELOW.

PAINTING WARRANT FOR ONE YEAR AGAINST DEFECT LIKE NOTICEABLE DISCOLOR, MILDEW, PEEL, CRACK, BLISTER, CHALK, IRREGULAR SHEEN CHANGE, SOFTNESS, TACKINESS, SUBMIT REQUESTED COLOR, TEXTURE SWATCH.

SUPPLIER: MAB, SHERWIN WILLIAMS OR APPROVED OTHERS SHEEN (GLOSS READING AT 60EF): FLAT 10+/- 3. SATIN 40 +/-5. SEMI GLOSS 60 +/-5. GLOSS 90 OR MORE.

SUBSTRATE: STARTING WORK SIGNIFIES ACCEPTANCE OF SURFACE. PROTECT OTHER WORK, REPLACE DAMAGE.

PREPARE: WOOD: SMOOTH, CLEAN, SAP SEALED, COMPATIBLY FILLED. STEEL: REMOVE GREASE, OIL, DIRT AND DUST; TOUCH UP SHOP PRIMER WITH COMPATIBLE OR SAME PRODUCT; REMOVE RUST TO BRIGHT METAL BEFORE RETOUCH. CONCRETE: VERIFY COMPATIBILITY WITH CURING PRODUCT; REMOVE DUST AND OXIDIZED SEPARATING COMPOUND. PROVIDE NORMAL MINOR PATCHING AND ALKALI NEUTRALIZATION. DRYWALL: CLEAN, DRY, SMOOTH DRY THICKNESS (BY TOOKE MARK II GAGE) (MIN. 2 COAT DRY MEASURE): EXTERIOR 5 MILS; INTERIOR 5 MILS; 4 MILS IF

LACQUER OR VARNISH; O IF STAIN, OIL. APPLICATION WITH PROPER CONSISTENCY AND TOUCH, SO PAINT FLOWS FREE OF BRUSH AND ROLLER MARK, BUBBLE, DUST, RUN, SAG AND HOLIDAY. SPREAD EVENLY. APPEARANCE: UNIFORM COLOR, TEXTURE AND SHEEN.

NEATNESS: DO NOT SMEAR, SPATTER OR OVERRUN ADJOINING COLOR OR MATERIAL. CUT IN LINES STRAIGHT. MILLWORK PRIMING: PROMPT AFTER DELIVERY. IF GRAIN RISE, SAND SMOOTH OR REPLACE. PAINT COMPATIBILITY: VERIFY BETWEEN EACH COAT. IF NECESSARY, CHANGE PRODUCT OR BLOCK COAT TO SEGREGATE INCOMPATIBILITY TYPE.

GYPSUM DRYWALL (SATIN) SPOT PRIME: LATEX PRIMER; COVER CEMENTED AREA I COAT: LATEX PRIMER TINTED TO MATCH FINISH COAT. 2 COAT: ALKYD ENAMEL. ROLL TO SMOOTH FINISH.

2 COATS: ALKYD ENAMEL. HARDWOOD NATURAL (GLOSS) SEALER/FILLER: OPEN GRAIN WOOD ONLY STAIN: OIL, MINWAX 3 COATS: MAB, SHERWIN WILLIAMS; 100% ACRYLIC.

WOOD, PLYWOOD (SEMI-GLOSS)

PRIMER: MEDIUM OIL UNDERCOAT ALKYD.

CEMENT FIBER SIDING AND PLANK PRIMER: PRIME PLUS \U+2122 2 COATS: MAB, SHERWIN WILLIAMS; 100% ACRYLIC.

1. SINGLE-SOURCE RESPONSIBILITY FOR TILE: OBTAIN EACH COLOR, GRADE, FINISH, TYPE, COMPOSITION AND VARIETY OF TILE FROM A SINGLE SOURCE WITH RESOURCES TO PROVIDE PRODUCTS OF CONSISTENT QUALITY IN APPEARANCE AND PHYSICAL PROPERTIES WITHOUT DELAYING PROGRESS OF THE WORK. 2. SINGLE-SOURCE RESPONSIBILITY FOR SETTING AND GROUTING MATERIALS: OBTAIN INGREDIENTS OF A UNIFORM QUALITY FROM ONE MANUFACTURER FOR EACH CEMENTITIOUS AND ADMIXTURE COMPONENT AND FROM ONE SOURCE OR PRODUCER FOR EACH AGGREGATE. 3. INSTALLER QUALIFICATIONS: ENGAGE AN EXPERIENCE INSTALLER WHO HAS SUCCESSFULLY COMPLETED TILE

DIVISION 15 - MECHANICAL

HVAC (PROVIDE DRAWINGS FOR REVIEW) DESCRIPTION: COMPLETE HVAC SYSTEM WITH DUCT INSULATION, REFRIGERANT LINE, DUCTWORK, REGISTER, GRILLE, DIFFUSER AND BALANCING.

STANDARD: ASHRAE GUIDE, SMACNA MANUAL, NATIONAL ELECTRIC CODE, LOCAL CODE. SUBMIT PRODUCT DATA, SHOP DRAWINGS, MAINTENANCE AND OPERATION INSTRUCTION. COORDINATION: CUT, PATCH, FURR BY OTHER SECTION; OR PAY FOR ACCESS OPENING. FFFICIFNCY: 12 SFFR

CONTROL: OFF/ON PER THERMOSTAT WITH DUAL SUMMER / WINTER, FAN ONLY.

BALANCE HEAT, VENT, COOL, THERMOSTAT, GRILLE, DAMPER, VANES. PLUMBING (PROVIDE DRAWINGS FOR REVIEW) STANDARD: BOCA PERMIT, FEE: OBTAIN, PAY. MATERIAL EQUIPMENT: STANDARD WATER SERVICE: I" YARD LINE, SHUTOFF VALVE AT WELL AND AT BUILDING ENTRY.

INSTALLATIONS SIMILAR IN MATERIAL, DESIGN AND EXTENT TO THAT INDICATED FOR PROJECT.

PIPE: HIGHEST QUALITY COPPER LAYOUT: SLOPE TO DRAIN VALVE, CUTOFF AT FIXTURE KEYED; MIN. 3/4" TO FIXTURE; AIR CHAMBER MIN 3/4" DIAM BY 12" AT FIXTURE. CLEAN-OUT AT 100 FT., EXIT FROM BUILDING AND CHANGE OF DIRECTION. CONCEAL PIPE OR RUN PARALLEL

TEST: CLOSE FIXTURE AND FILL VENT FOR 15 MINUTES WATER-TIGHT. HOT AND COLD WATER WATER-TIGHT AT 100 PSI

SEWAGE PROCESSING STANDARD: PER COUNTY ENGINEER PERMIT, INSPECTION, FEE: OBTAIN AND PAY FOR; PROVIDE NECESSARY DRAWINGS, MAINTENANCE AND OPERATION INSTRUCTION.

INSTRUCTION.

WITNESSED BY OWNER'S REPRESENTATIVE.

HOT WATER PIPING TO BE INSULATED.

SYSTEM: PROVIDE COMPLETE DESIGN TO ABOVE STANDARD INCLUDING ALL TANKS, GREASE TRAPS, DRAIN FIELDS, ETC. EXECUTION: TO STANDARD: TEST, CONNECT AND ADJUST TO GOOD WORKING ORDER WATER WELL STANDARD: PER COUNTY ENGINEER

PERMIT, INSPECTION, FEE: OBTAIN AND PAY FOR; PROVIDE NECESSARY DRAWINGS, MAINTENANCE AND OPERATION

SYSTEM: PROVIDED BY OWNER. CONTRACTOR TO COORDINATE HOOK UP AND OPERATION. EXECUTION: TO STANDARD: TEST: CONNECT AND ADJUST TO GOOD WORKING ORDER. SPRINKLER (WHEN REQUIRED)

THIS HOME IS TO BE SPRINKLERED IN ACCORDANCE WITH LOCAL CODE AND PER COUNTY ENGINEER. SYSTEM SHALL BE

DESIGNED AND INSTALLED BY A CERTIFIED SPRINKLER CONTRACTOR.

PERMIT FEE: OBTAIN; PAY

DIVISION 16 - ELECTRICAL ELECTRICAL (PROVIDE DRAWINGS FOR REVIEW) INCLUDE WIRING FOR LIGHT, POWER, LIGHT FIXTURE, LAMP, PANEL BOARD AND DISTRIBUTION; CONNECT EQUIPMENT; WIRE CONTROL. BUILDING WIRE COPPER. STANDARD: NATIONAL ELECTRIC CODE: HIGH QUALITY

PANEL: QUICK MAKE, QUICK BREAK MULTIBREAKER; LIST CIRCUITS, UL LABEL; BY FEDERAL, GE, SQUARE D, WESTINGHOUSE.

MOTOR: SET, CONNECT WITH STARTER, CONTROLLER, PILOT,; DISCONNECT SWITCH. GROUND CONDUIT, MOTOR, STARTER AND OTHER ELECTRICAL EQUIPMENT. ELECTRICAL ROUGHIN (PROVIDE DRAWINGS FOR PERMIT) INCLUDE: PRIMARY,. CONSTRUCTION POWER AND LIGHT, AC AND TEST POWER.

WIRING DEVICE: SWITCH HEAVY DUTY, QUIET; RAIN TIGHT OF EXTERIOR.

STANDARD: LOCAL CODE, NATIONAL ELECTRICAL CODE; HIGH QUALITY. PERMIT FEE: OBTAIN, PAY FOR. GENERAL CONTRACTOR TO PROVIDE AND OBTAIN TEMPORARY POWER.

SUBMIT: PRODUCT DATA, SAMPLE USEABLE WORK IF APPROVED.

TELEPHONE: OUTLET BOX PLATE MATCH FINISH

ALARM SYSTEM (PROVIDE DRAWINGS FOR REVIEW) INCLUDE: WIRING FOR ALL DEVICES WIRING DEVICES: DOOR CONTACTS, WINDOW CONTACTS, MOTION DETECTORS, GLASS BREAK DETECTORS, PRESSURE SENSORS, SMOKE DETECTORS, HEAT DETECTORS, CO2 DETECTORS & WATER DETECTORS. PANEL: MULTIZONE PANEL TO HANDLE PRESENT DEMAND PLUS 2 ADDITIONAL ZONES FOR FUTURE.

KEYPAD: PROVIDE 2 LCD KEYPADS AS SHOWN ON ELECTRICAL SHEETS. CENTRAL MONITORING: PROVIDE INFORMATION FOR OWNER TO CHOOSE. Robin J. Kohn, AIA Regis W. Kubit, PE

523 Kimberton Road, Suite 11B Phoenixville, PA 19460 tel. (610) 917-8831 fax (610) 917-8836 email mail@betzwood.com http://www.betzwood.com

Robin I. Kohn AlA Commonwealth of Pennsylvania License No. RA-11327-X

> Contact Person: Edward M. Happ (610) 917-8831

PREPARED BY

PROJECT NO. DRAWN BY CHK'D BY B 2126 l FMF NO. DATE ISSUE BY ISSUED FOR REVIEW 05-05-04 ISSUED FOR CLIENT REVIEW 06-04-04 ISSUED FOR CLIENT REVIEW 06-24-04 ISSUED FOR PRE-BID 07-23-04 ISSUED FOR BID 08-16-04 ISSUED FOR CONSTRUCTION 10-01-04 FMH REISSUED FOR CONSTRUCTION 12-07-04 EMH APPROVED BY CURRENT DATE Robin J. Kohn, AIA December 07, 2004

Camp Residence


LOT #5 DICKSON DRIVE MALVERN, PA 19355


CHARLESTOWN TWP. CHESTER COUNTY


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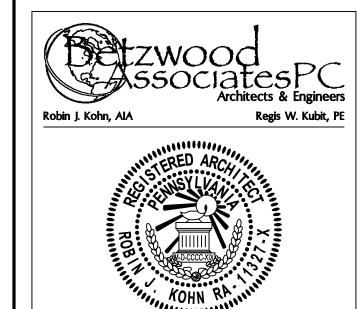
SPECIFICATIONS

SHEET NUMBER



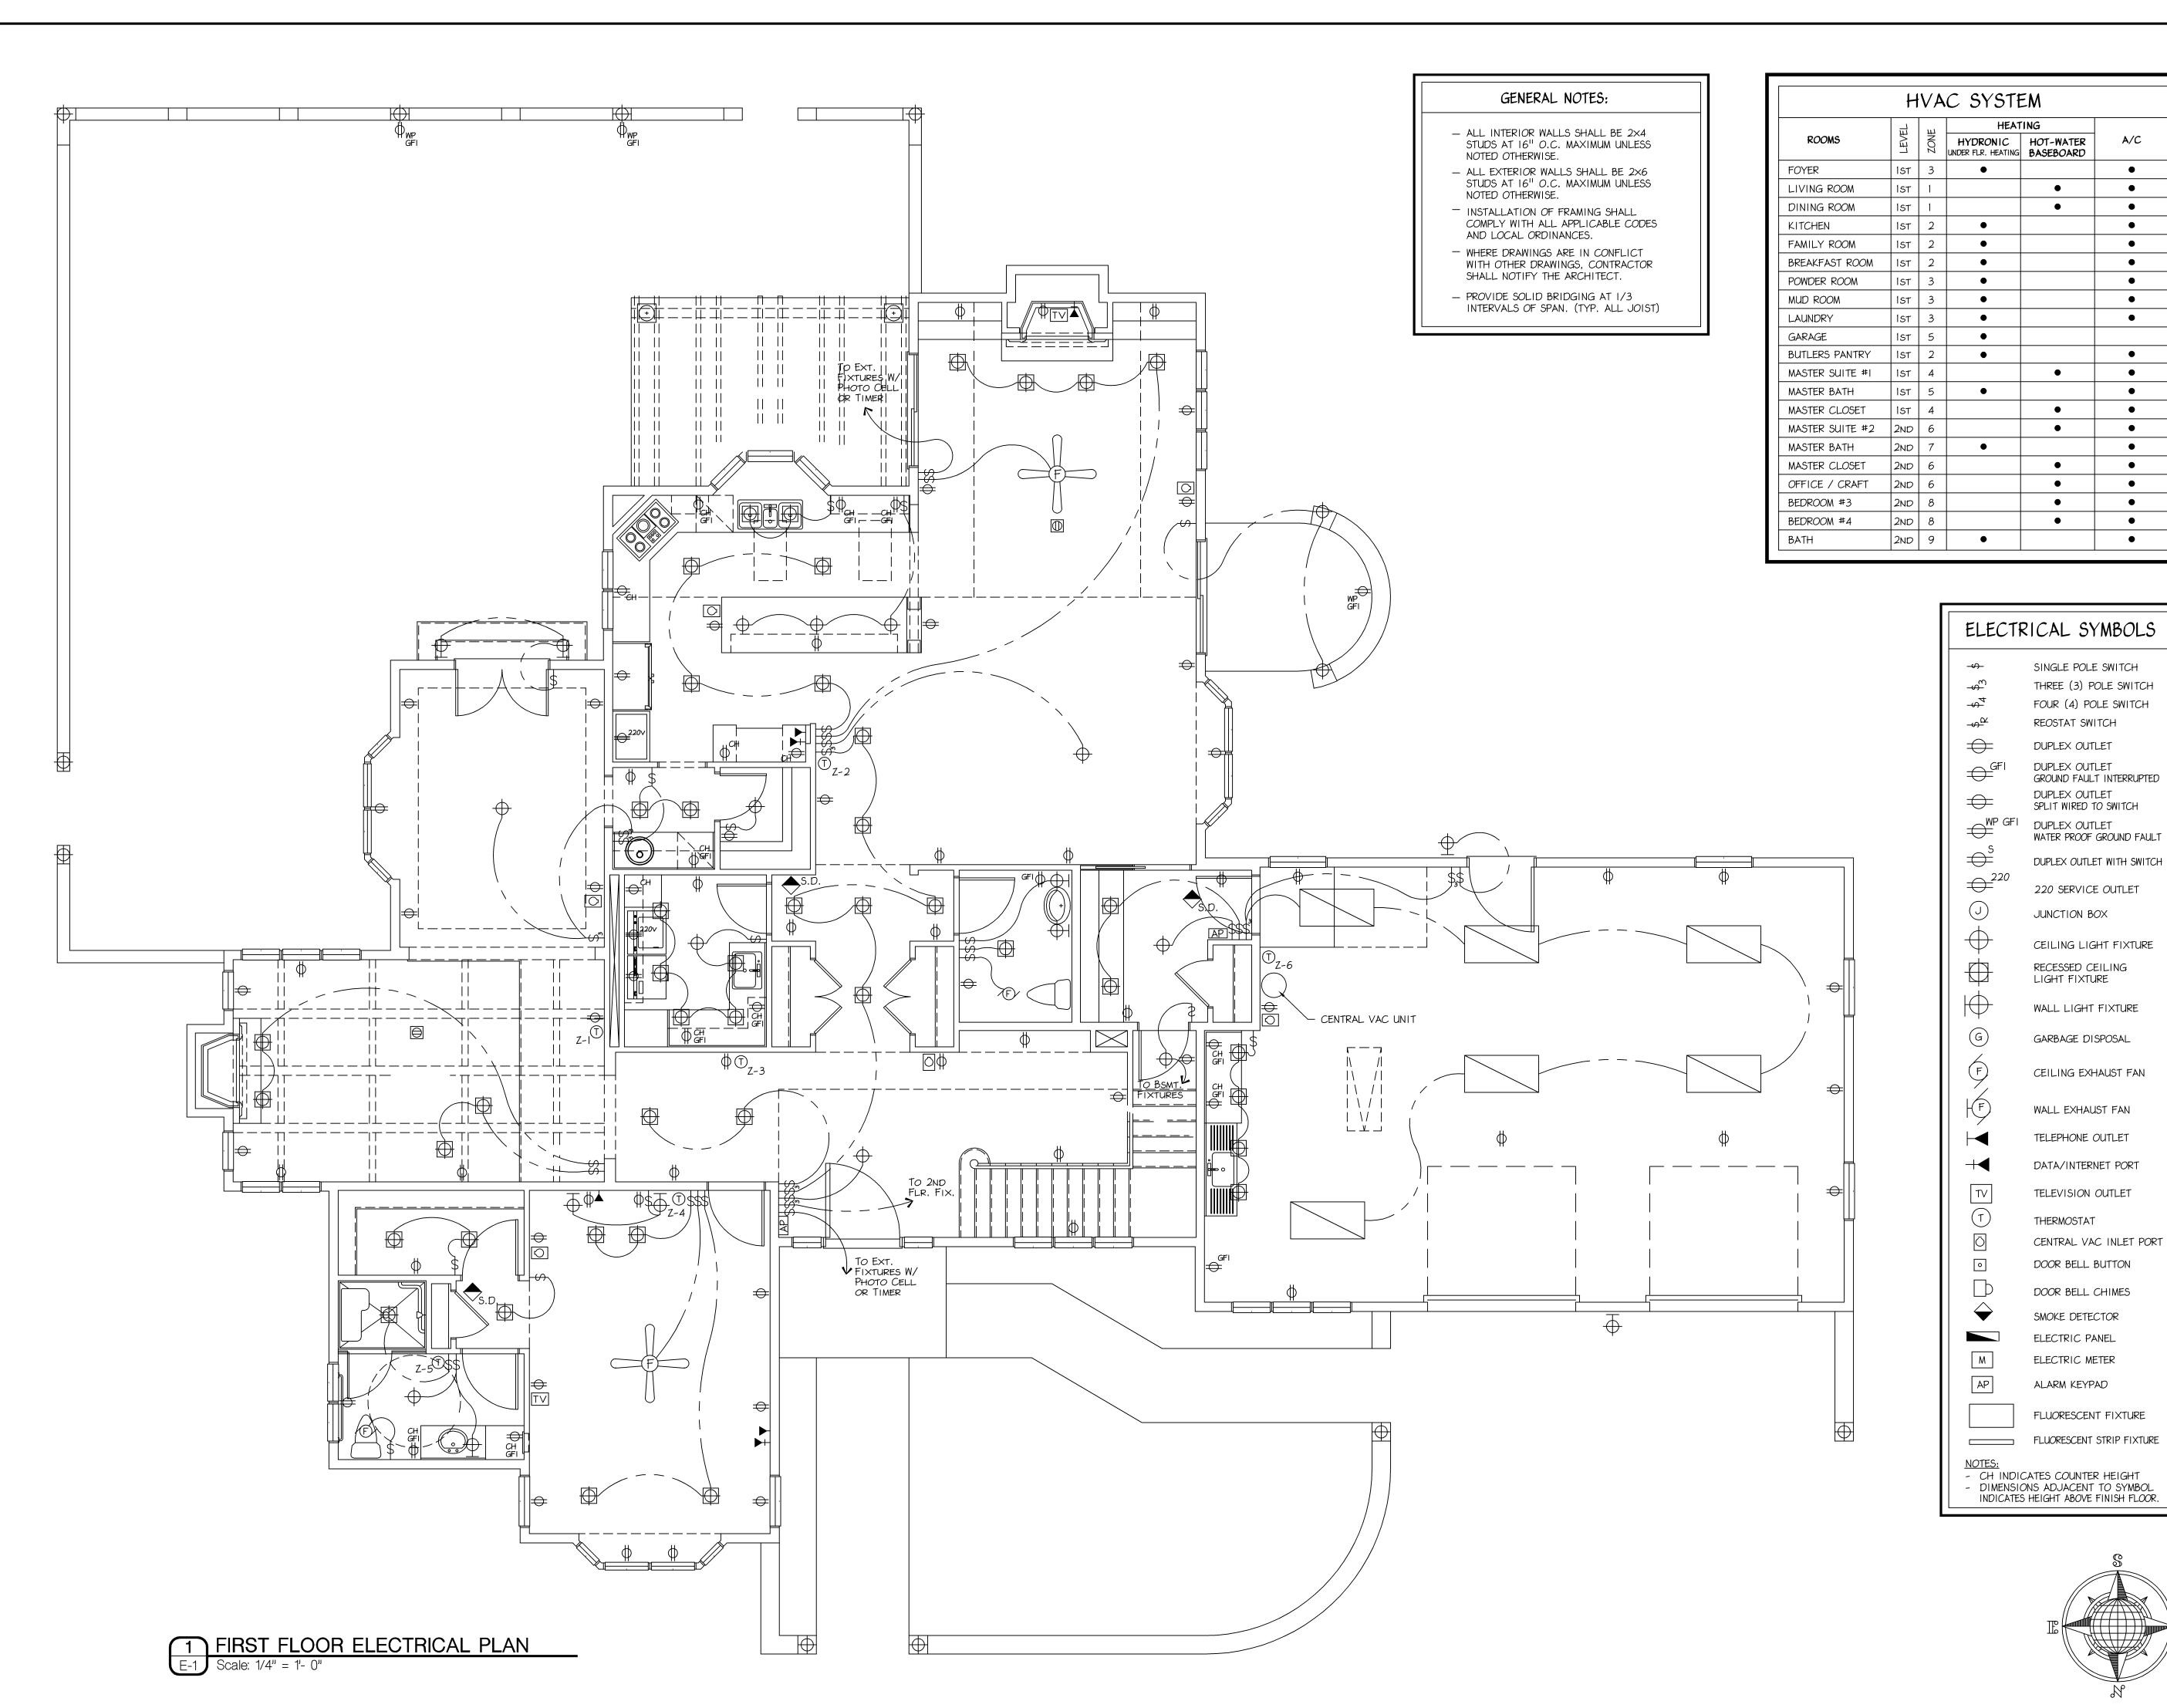

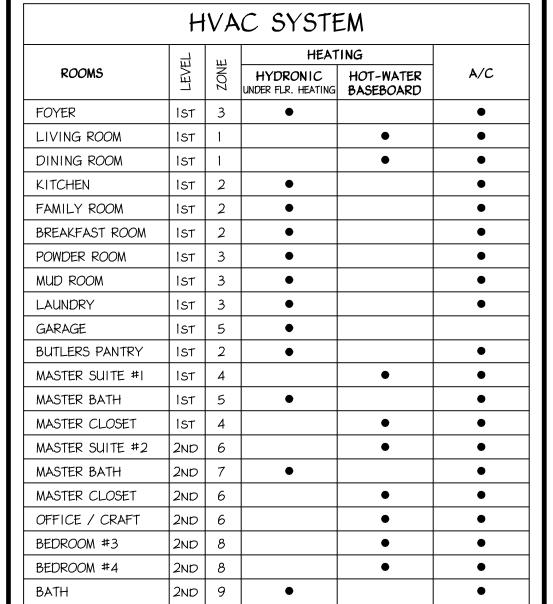

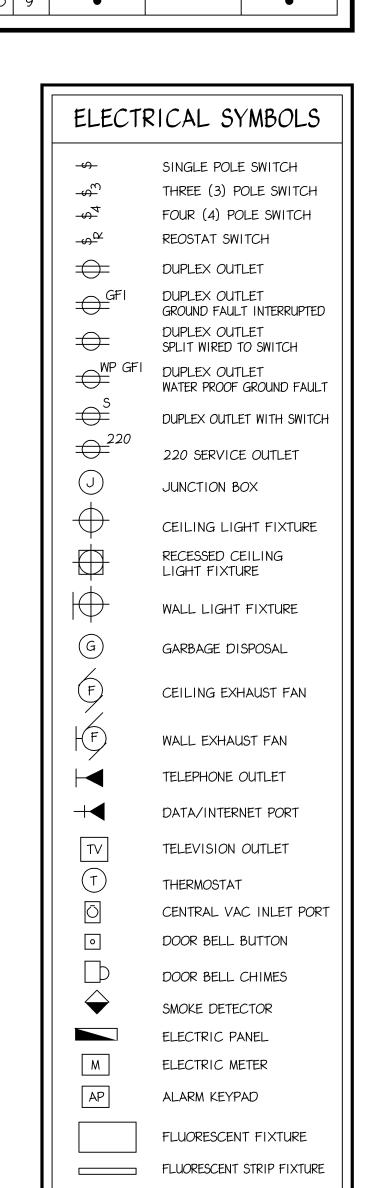

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1	05-05-04	ЕМН	ISSUED FOR REVIEW	
2	06-04-04	RRG	ISSUED FOR CLIENT REVIEW	
3	06-24-04	ЕМН	ISSUED FOR CLIENT REVIEW	
4	07-23-04	ЕМН	ISSUED FOR PRE-BID	
5	08-16-04	ЕМН	ISSUED FOR BID	
6	10-01-04	ЕМН	ISSUED FOR CONSTRUCTION	
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Robin J. Kohn, AIA			December 07, 2004	

Camp Residence

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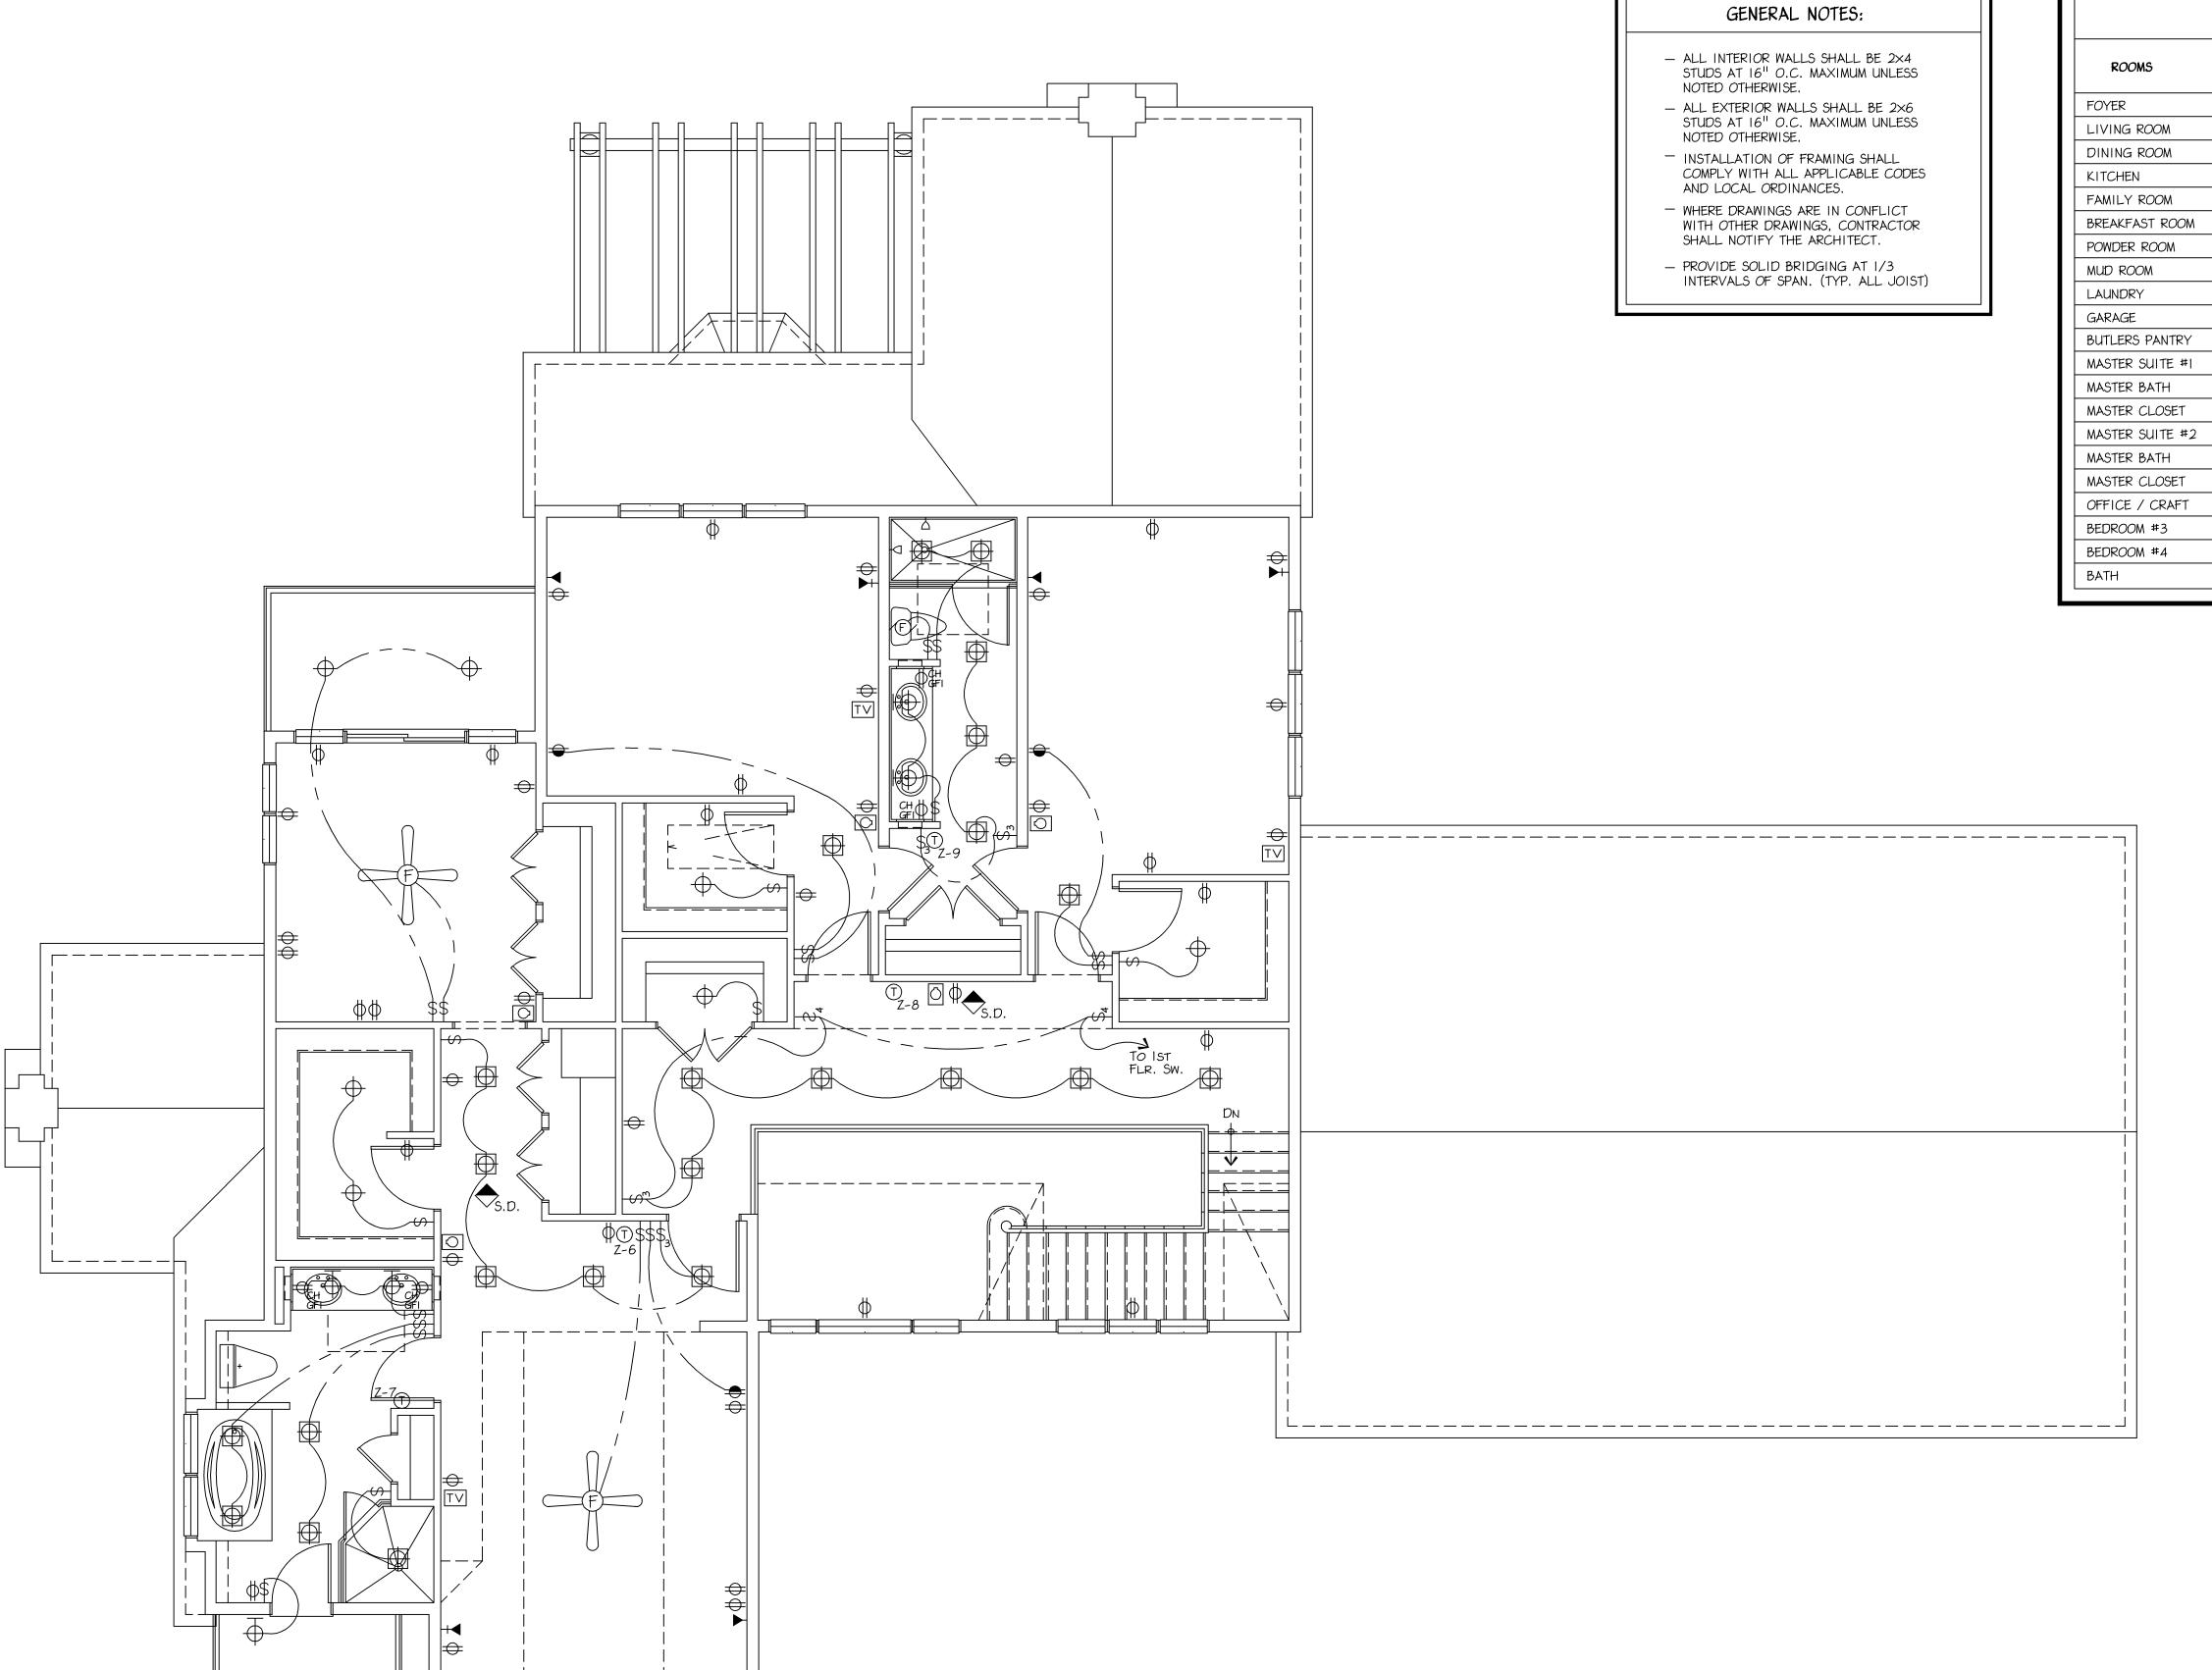
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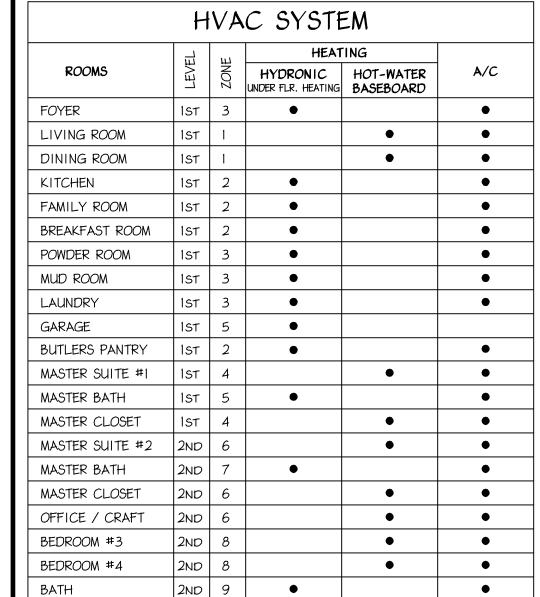
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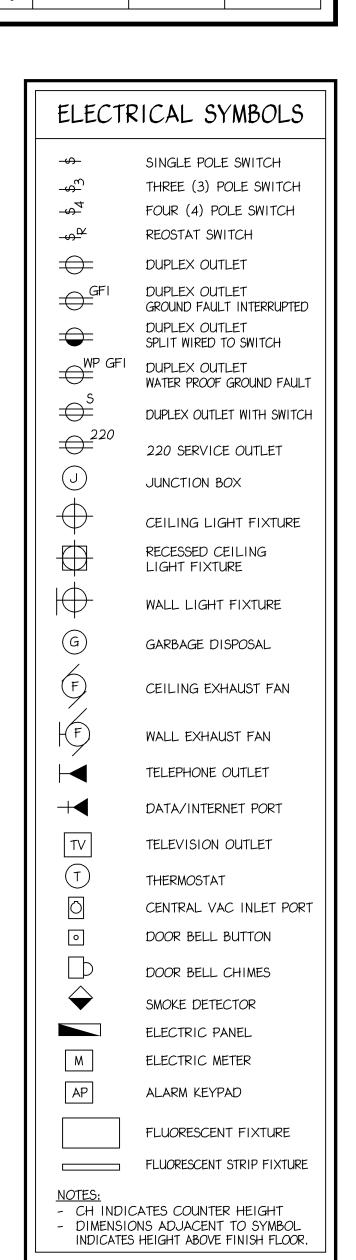
FIRST FLOOR ELECTRICAL PLAN


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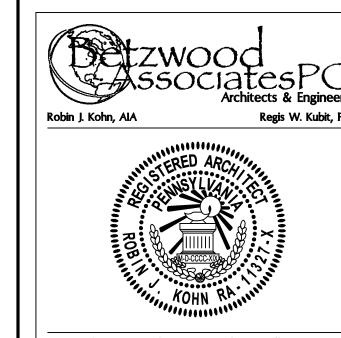
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3	06-24-04	ЕМН	ISSUED FOR CLIENT REVIEW					
4	07-23-04	ЕМН	ISSUED FOR PRE-BID					
5	08-16-04	EMH	ISSUED FOR BID					
6	10-01-04	EMH	ISSUED FOR CO	NSTRUCTION				
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Robin	J. Kohn, AIA		Decembe	er 07, 2004				

Camp Residence

LOT #5 DICKSON DRIVE MALVERN, PA 19355

CHARLESTOWN TWP.
CHESTER COUNTY

SHEET TITLE

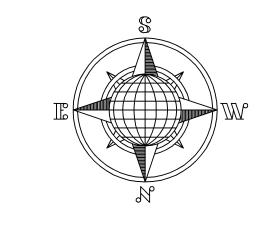SECOND FLOOR ELECTRICAL PLAN

SHEET NUMBER

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